BANK RUN SITE IMPROVEMENTS PHASE ONE

PROJECT ADDRESS

5636 LOCKBOURNE RD LOCKBOURNE, OHIO 43137


PACKAGE

100% CONSTRUCTION DOCUMENTS

OCTOBER 31, 2025

MKSK PROJECT#

c25114

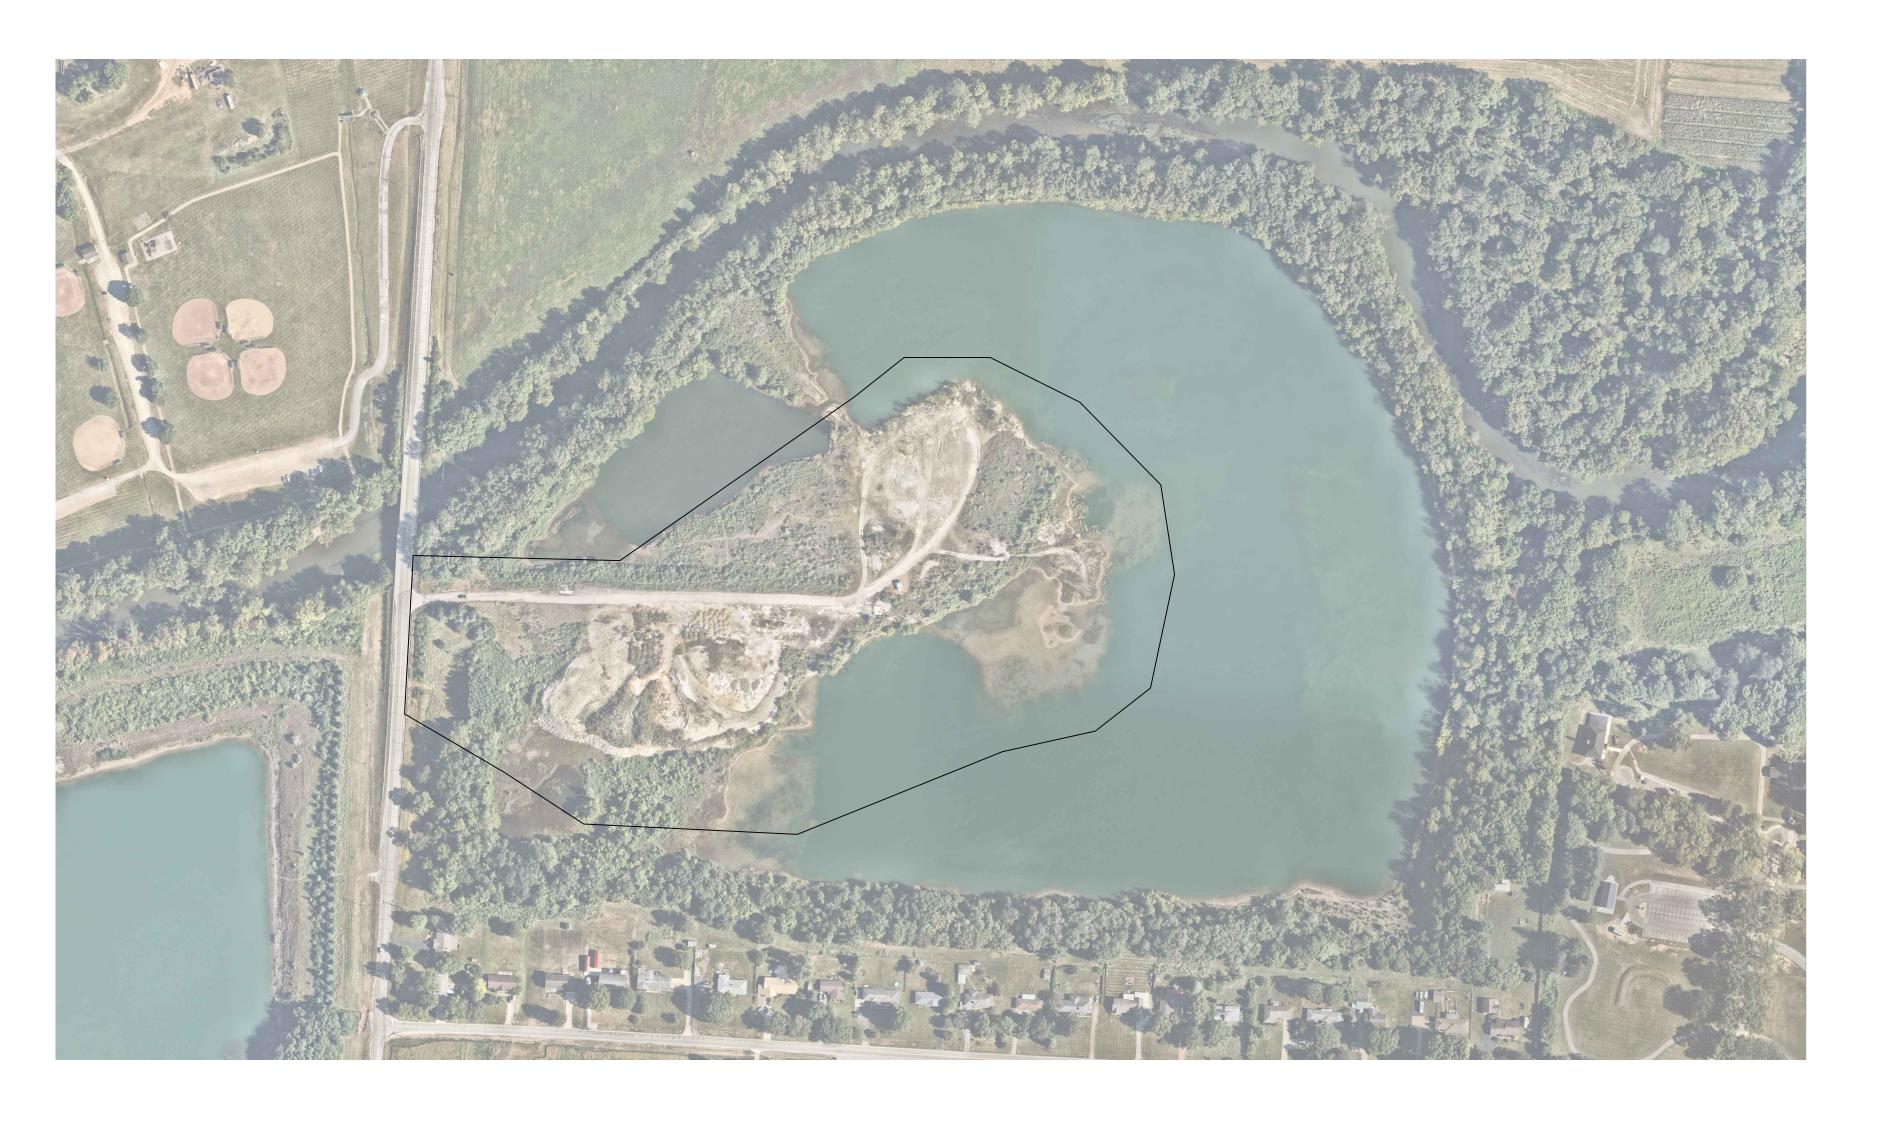

OWNER:

COLUMBUS & FRANKLIN COUNTY METRO PARKS

1069 West Main Street | Westerville, Ohio | 4308

DRAWINGS PREPARED BY:





VICINITY MAP
N.T.S

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GENERAL NOTES

A. BASE INFORMATION

- 1. THE BASE MAPPING / SURVEY WAS PREPARED BY ARCADIS. 8101 NORTH HIGH STREET, SUITE 100 COLUMBUS, OH 43235 (614-818-4900). FIELD VERIFY EXISTING CONITIONS AND REPORT ANY DISCREPANCIES TO THE OWNER'S REPRESENTATIVE PRIOR TO COMMENCING WITH WORK.
- 2. THE PLANS ASSUME THE LAYOUT AND STAKING WILL BE ACCOMPLISHED USING TOTAL STATIONING/ DIGITAL METHODS ANY INFORMATION PROVIDED IS INTENDED TO SUPPORT INFORMATION ALREADY CONTAINED IN CAD FILES USED FOR DOCUMENTING LAYOUT AND STAKING. CAD FILES DELINEATING ALL GRADING AND HARDSCAPE ELEMENTS SHOWN IN THESE PLANS CAN BE PROVIDED TO THE CONTRACTOR UPON REQUEST.
- 3. NORTHING AND EASTING POINTS, WHERE SHOWN ARE BASED ON STATE PLANE COORDINATE SYSTEM AS REFERENCED FROM THE SITE SURVEY.
- 4. THE LIMIT OF CONSTRUCTION WORK LINE SHOWN DEFINES THE LIMITS OF WORK IN THIS CONTRACT.
- 5. LIMITS OF CONSTRUCTION AND CONTRACTOR STAGING AREAS SHALL BE LIMITED TO AREAS DESIGNATED BY THE CONTRACT DOCUMENTS.

B. GENERAL REQUIREMENTS

- 1. UNLESS OTHERWISE NOTED FOR THE PROJECT'S SITE DEVELOPMENT AND SPECIFICATIONS DOCUMENTS, COLUMBUS AND FRANKLIN COUNTY METROPARKS (REFERRED TO AS "METROPARKS" HEREINAFTER) SHALL SERVE AS THEIR OWN OWNER'S REPRESENTATIVE.
- 2. CONTRACTOR SHALL BE RESPONSIBLE FOR BECOMING FAMILIAR WITH PROJECT DRAWINGS AND SPECIFICATIONS FOR ALL DIVISIONS OF WORK.
- 3. VERIFY EXISTING CONDITIONS AND NOTIFY OWNER'S REPRESENTATIVE OF ANY DISCREPANCY BETWEEN THE PLANS AND ACTUAL SITE CONDITIONS. NO WORK SHALL BE PERFORMED WHERE SUCH DISCREPANCIES EXIST. COMMENCEMENT OF CONSTRUCTION INDICATES THE CONTRACTOR ACCEPTS THE ACTUAL SITE CONDITIONS AS MATCHING THE EXISTING CONDITIONS DEPICTED ON THE PROJECT DOCUMENTS AND ASSUMES FULL RESPONSIBILITY FOR ALL NECESSARY CORRECTIONS TO WORK CONSTRUCTED UNDER HIS CONTRACT.
- DAMAGE OF EXISTING SITE STRUCTURES AND AMENITIES "TO REMAIN" TO THE OWNER'S REPRESENTATIVE. CONTRACTOR SHALL BE RESPONSIBLE FOR ALL SUBSEQUENT DAMAGE AT NO COST TO THE OWNER OR LANDSCAPE ARCHITECT.

4. PRIOR TO COMMENCING WORK, REPORT AND DOCUMENT ANY

- 5. COORDINATE WORK RELATED TO OTHER TRADES AND THE GENERAL CONSTRUCTION OF THE PROJECT. ALL MEANS, METHODS, SEQUENCING AND PROCEDURES OF THE WORK ARE THE RESPONSIBILITY OF THE CONTRACTOR.
- 6. VERIFY THE CONDITION AND COMPLETENESS OF ALL WORK PERFORMED BY OTHERS RELATED TO THEIR WORK RESPONSIBILITIES INCLUDING THE VERIFICATION OF EXISTING ELEVATIONS OR STRUCTURES PRIOR TO INITIATING CONSTRUCTION. IMMEDIATELY NOTIFY THE OWNER'S REPRESENTATIVE IF ANY SITE CONDITIONS ARE INCOMPLETE, MISSING OR DAMAGED.
- 7. NOTIFY OWNER'S REPRESENTATIVE 72 HOURS IN ADVANCE OF ANY PLANNED UTILITY INTERUPTION.

C. PROTECTION

- CAREFULLY PRESERVE BENCHMARKS, PROPERTY CORNERS, REFERENCE POINTS, HUBS, STAKES AND OTHER SURVEY REFERENCE MONUMENTS OR MARKERS. IF ANY PINS OR MONUMENTS ARE DISTURBED, DAMAGED, OR DESTROYED BY THE CONTRACTOR, THEY SHALL BE ACCURATELY REPLACED BY A REGISTERED PROFESSIONAL SURVEYOR AT THE COMPLETION OF THE PROJECT AND AT THE CONTRACTOR'S EXPENSE.
- 2. KNOWN EXISTING UTILITY LINES ARE NOTED ON THE DRAWINGS. THE CONTRACTOR SHALL BE SOLELY RESPONSIBLE FOR PROTECTING THEM DURING EXCAVATION. ANY DAMAGE TO UTILITIES AND ANY OTHER PROPERTY TO REMAIN SHALL BE REPAIRED IN KIND. IF CONTRACTOR ENCOUNTERS ANY UNFORESEEN UTILITY, NOTIFY THE OWNER'S REPRESENTATIVE FOR FURTHER DIRECTION PRIOR TO PROCEEDING WITH THE WORK.
- 3. CONTACT THE **OUPS OHIO UTILITY PROTECTION SERVICE** A MINIMUM OF 48 HOURS IN ADVANCE OF WORK TO BE PERFORMED WITHIN THE CONSTRUCTION SITE AND IS RESPONSIBLE FOR COORDINATING ANY RELOCATIONS OR ADJUSTMENT/REPLACEMENT OF AFFECTED UTILITIES AND APPURTENANCES.
- 4. OBTAIN PERMITS AND TEMPORARY EASEMENTS FOR THE WORK AS REQUIRED AND COMPLY WITH ALL LAWS, ORDINANCES, RULES AND REGULATIONS OF THE LOCAL JURISDICTION, THE STATE, AND ALL OTHER AUTHORITIES HAVING JURISDICTION.

D. PUBLIC SAFETY

- 1. DO NOT CLOSE OR OBSTRUCT STREETS, WALKS, OR OTHER OCCUPIED OR USED FACILITIES WITHOUT PERMISSION FROM THE CITY AND AUTHORITIES HAVING JURISDICTION.
- 2. PROVIDE ALL NECESSARY SAFETY MEASURES DURING CONSTRUCTION OPERATIONS TO PROTECT THE PUBLIC ACCORDING TO ALL APPLICABLE CODES AND TOWNSHIP PRACTICES. EGRESS AND INGRESS TO ALL BUILDINGS MUST BE MAINTAINED AT ALL TIMES.
- 3. PROVIDE FOR SAFE VEHICULAR AND PEDESTRIAN PASSAGE THROUGH THE CONSTRUCTION SITE AT ALL TIMES BY THE USE OF TRAFFIC CONTROL DEVICES, BARRICADES, SIGNAGE, PLATING, TEMPORARY ACCESS WALKS AND DRIVES, FLAGMEN OR OTHER RECOGNIZED PROTECTIVE METHODS.

E. EROSION CONTROL

- 1. PROVIDE TEMPORARY AND PERMANENT EROSION AND SEDIMENT CONTROL ITEMS AS REQUIRED BY GOVERNING AGENCY, AS REQUIRED BY PERMIT, AS INDICATED ON THE PLANS, AND AS NOTED IN THE SPECIFICATIONS. INSTALL TEMPORARY EROSION AND SEDIMENT CONTROL ITEMS PRIOR TO CLEARING AND COMMENCING EARTHWORK.
- 2. MAINTAIN, KEEP CLEAN AND FULLY OPERATIONAL SITE DRAINAGE FACILITIES AND EXISTING EROSION AND SEDIMENT CONTROL MEASURES (SILT FENCE, AND/OR OTHER MEASURES) DURING CONSTRUCTION. PROVIDE ADDITIONAL MEASURES AS NECESSARY TO MINIMIZE ADVERSE IMPACTS TO THE ADJACENT WATER BODIES, SURFACES AND STORM SEWERS ACCORDING TO ALL APPLICABLE FEDERAL/STATE LAWS AND REGULATIONS.
- 3. STORMWATER BMP'S SHALL BE INSPECTED ONCE EVERY SEVEN DAYS, AND WITHIN 24 HOURS OF A 0.5 INCH OR GREATER RAINFALL, OR BY WHAT IS REQUIRED BY PERMIT, WHICHEVER IS GREATER. CLEAN SEDIMENT BASINS AND CATCH BASINS AS REQUIRED TO MAINTAIN EFFECTIVENESS OR AS DIRECTED.

F. SITE CLEANING

1. PROVIDE APPROPRIATE CONTROL MEASURES DURING CONSTRUCTION TO PREVENT AIRBORNE DUST.

- 2. MAINTAIN THE CONSTRUCTION SITE AT ALL TIMES IN A PRESENTABLE CONDITION ACCEPTABLE TO METROPARKS UNTIL THE COMPLETION AND ACCEPTANCE OF THE PROJECT. MAINTAIN ADJOINING STREETS. SIDEWALKS AND DRIVES FREE OF SOIL, MUD AND EXCESS CONSTRUCTION MATERIALS. BROOM SWEEP OR WASH AS NEEDED OR DIRECTED.
- 3. REPAIR OR REPLACE DAMAGED UTILITIES, PAVEMENTS, STRUCTURES, LANDSCAPING, STREET SIGNS AND MONUMENTS WITHIN THE CONSTRUCTION SITE CAUSED BY THE CONTRACTOR, SUB CONTRACTOR, SUPPLIES OR WORKERS. SUCH REPAIR OR REPLACEMENT SHALL BE "IN-KIND" AS DIRECTED. PROTECT ALL WORK AND PROPERTY WITHIN THE CONSTRUCTION SITE.
- 4. REMOVE AND DISPOSE OF LEGALLY ALL RUBBISH AND CONSTRUCTION DEBRIS IMMEDIATELY, UNLESS OTHERWISE INDICATED ON DRAWINGS.

ABBREVIATIONS

ENG

EOP

EQ

EW

FTG

FTR

GAL

GALV

GC

GEN

GRT

MAX

MED

PCC

PERF

ENGINEER

EQUIPMENT

EACH WAY

EQUAL

FINISH

FUTURE

GAUGE

GALLON

GENERAL

HOSE BIB

HANDICAPPED

INSIDE DIAMETER

HORIZONTAL

INLET DRAIN

INCH, INCHES

JUNCTION BOX LOW POINT

LIGHT FIXTURE

MAXIMUM

MEDIUM MANHOLE

MINIMUM

NOMINAL

OVERALL

ON CENTER

PERFORATED

MECHANICAL

MANUFACTURER

MISCELLANEOUS

MULTI-STEM NOT IN CONTRACT

NOT TO SCALE

OUTSIDE DIAMETER

PRECAST CONCRETE

INCLUDED

INTERIOR

INVERT

HIGH POINT

HEIGHT

GALVANIZED

EDGE OF PAVEMENT

EXISTING EXTERIOR

FACE OF BUILDING

FINISH FLOOR ELEVATION

FACE OF CURB

FINISH GRADE

FACE OF WALL

FULL TO GROUND

GENERAL CONTRACTOR

GRATE ELEVATION


FOOT, FEET

PERP ANCHOR BOLT PERPENDICULAR AMERICANS WITH DISABILITIES ACT PIP POURED IN PLACE ADDENDUM PLT PLANTING AREA ADD ADJ ADJACENT PLUM PLUMBING AGGREGATE POB POINT OF BEGINNING POT POINT OF TANGENT ALIGN ALTERNATE PP PEAT POTS ALUMINUM PLANTS PER POT **APPROXIMATE** PROP PROPOSED PRTR ARCH ARCHITECT PRESERVATIVE PREATED PT **AUTOMATIC** POINT ALIGN WITH ARCHITECTURE PTP PRESSURE TREATED PINE ALIGN WITH CENTER POTABLE WATER BALLED AND BURLAPPED PVMT PAVEMENT BACK OF CURB QC QUICK COUPLER QTY QUANTITY BELOW BETWEEN **RADIUS** RD ROUND **BITUMINOUS** BLDG REINF REINFORCED BUILDING BLK BLOCK REM REMOVE BOT BOTTOM REQD REQUIRED REV REVISION BARE ROOM BRICK RIM RIM ELEVATION **BOTH SIDES** RWS ROOT WATERING SYSTEM BOTTOM OF CURB SCH SCHEDULE BTF BOTTOM OF FOOTING SEC SECTION BTS BOTTOM OF STEPS SHT SHEET BOTTOM OF WALL SIM SIMILAR BVL BEVEL SNT **SEALANT** BACK OF WALL SPEC SPECIFICATION BEYOND SPR SPREAD CAL CALIPER SS STAINLESS STEEL **CATCH BASIN** ST SINGLE TRUNK CHAMFER STD STANDARD CAST IN PLACE STRUC STRUCTURAL CONTROL JOINT SQ SQUARE CENTER LINE TBD TO BE DETERMINED CONCRETE MASONRY UNIT TC TOP OF CURB CO CLEANOUT TCB TOP OF COLUMN BASE COL COLUMN TCM TOP OF COLUMN CONCRETE TEMP **TEMPERATURE** CONT CONTINUOUS TFG TOP OF FOOTING CRS COURSE TOP OF STAIRS **CLEAR TRUNK** TW TOP OF WALL CTR CENTER TYP TYPICAL DIAMETER AT BREAST HEIGHT DBH UC UNDER CUT DEM DEMOLISH UNO UNLESS NOTED OTHERWISE DIA DIAMETER **VERT** VERTICAL DIM DIMENSION VERIFY IN FIELD VIF DOWNSPOUT DETAIL DTL WITHOUT W/0 DRAWING DWG WLA WATER LEVEL AVERAGE EACH WLS WATER LEVEL STATIONARY **EXPANSION JOINT** WM WIRE MESH **ELEVATION** WATERPROOFING ELEC ELECTRICAL WR WASTE RECEPTACLE **ENCLOSURE** WELDED WIRE FABRIC

LEGEND

DETAIL NUMBER SHEET NUMBER



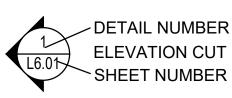

ALIGN


— - — CENTERLINE

PROJECT LIMITS / LIMIT OF WORK

000.00 ELEVATION

DIMENSION

RADIUS

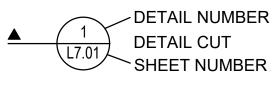





ALIGN

→ BREAKLINE

100% CONSTRUCTION DOCUMENTS

MKSK

Urban Design

462 SOUTH LUDLOW ALLEY COLUMBUS, OH 43215

614.621.2796 MKSKSTUDIOS.COM

BANK RUN SITE

IMPROVEMENTS

PHASE ONE

5636 LOCKBOURNE RD

LOCKBOURNE, OH

COLUMBUS AND FRANKLIN COUNTY METRO PARKS


Planning

client / owner

project name

project address

Landscape Architecture

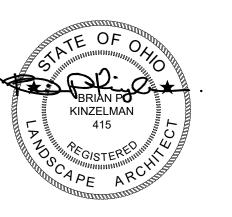

project number

c25114

issue date 10.31.2025

> sheet name GENERAL NOTES

sheet number



1.) SURVEY CONDUCTED IN FEBRUARY 2024 AND PROVIDED BY OWNER.
2.) AERIAL SHOWN PROVIDED BY NEARMAP AND IS CURRENT AS OF AUGUST 31, 2025

MKSK

Landscape Architecture **Urban Design** Planning


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COLUMBUS AND FRANKLIN COUNTY METRO PARKS

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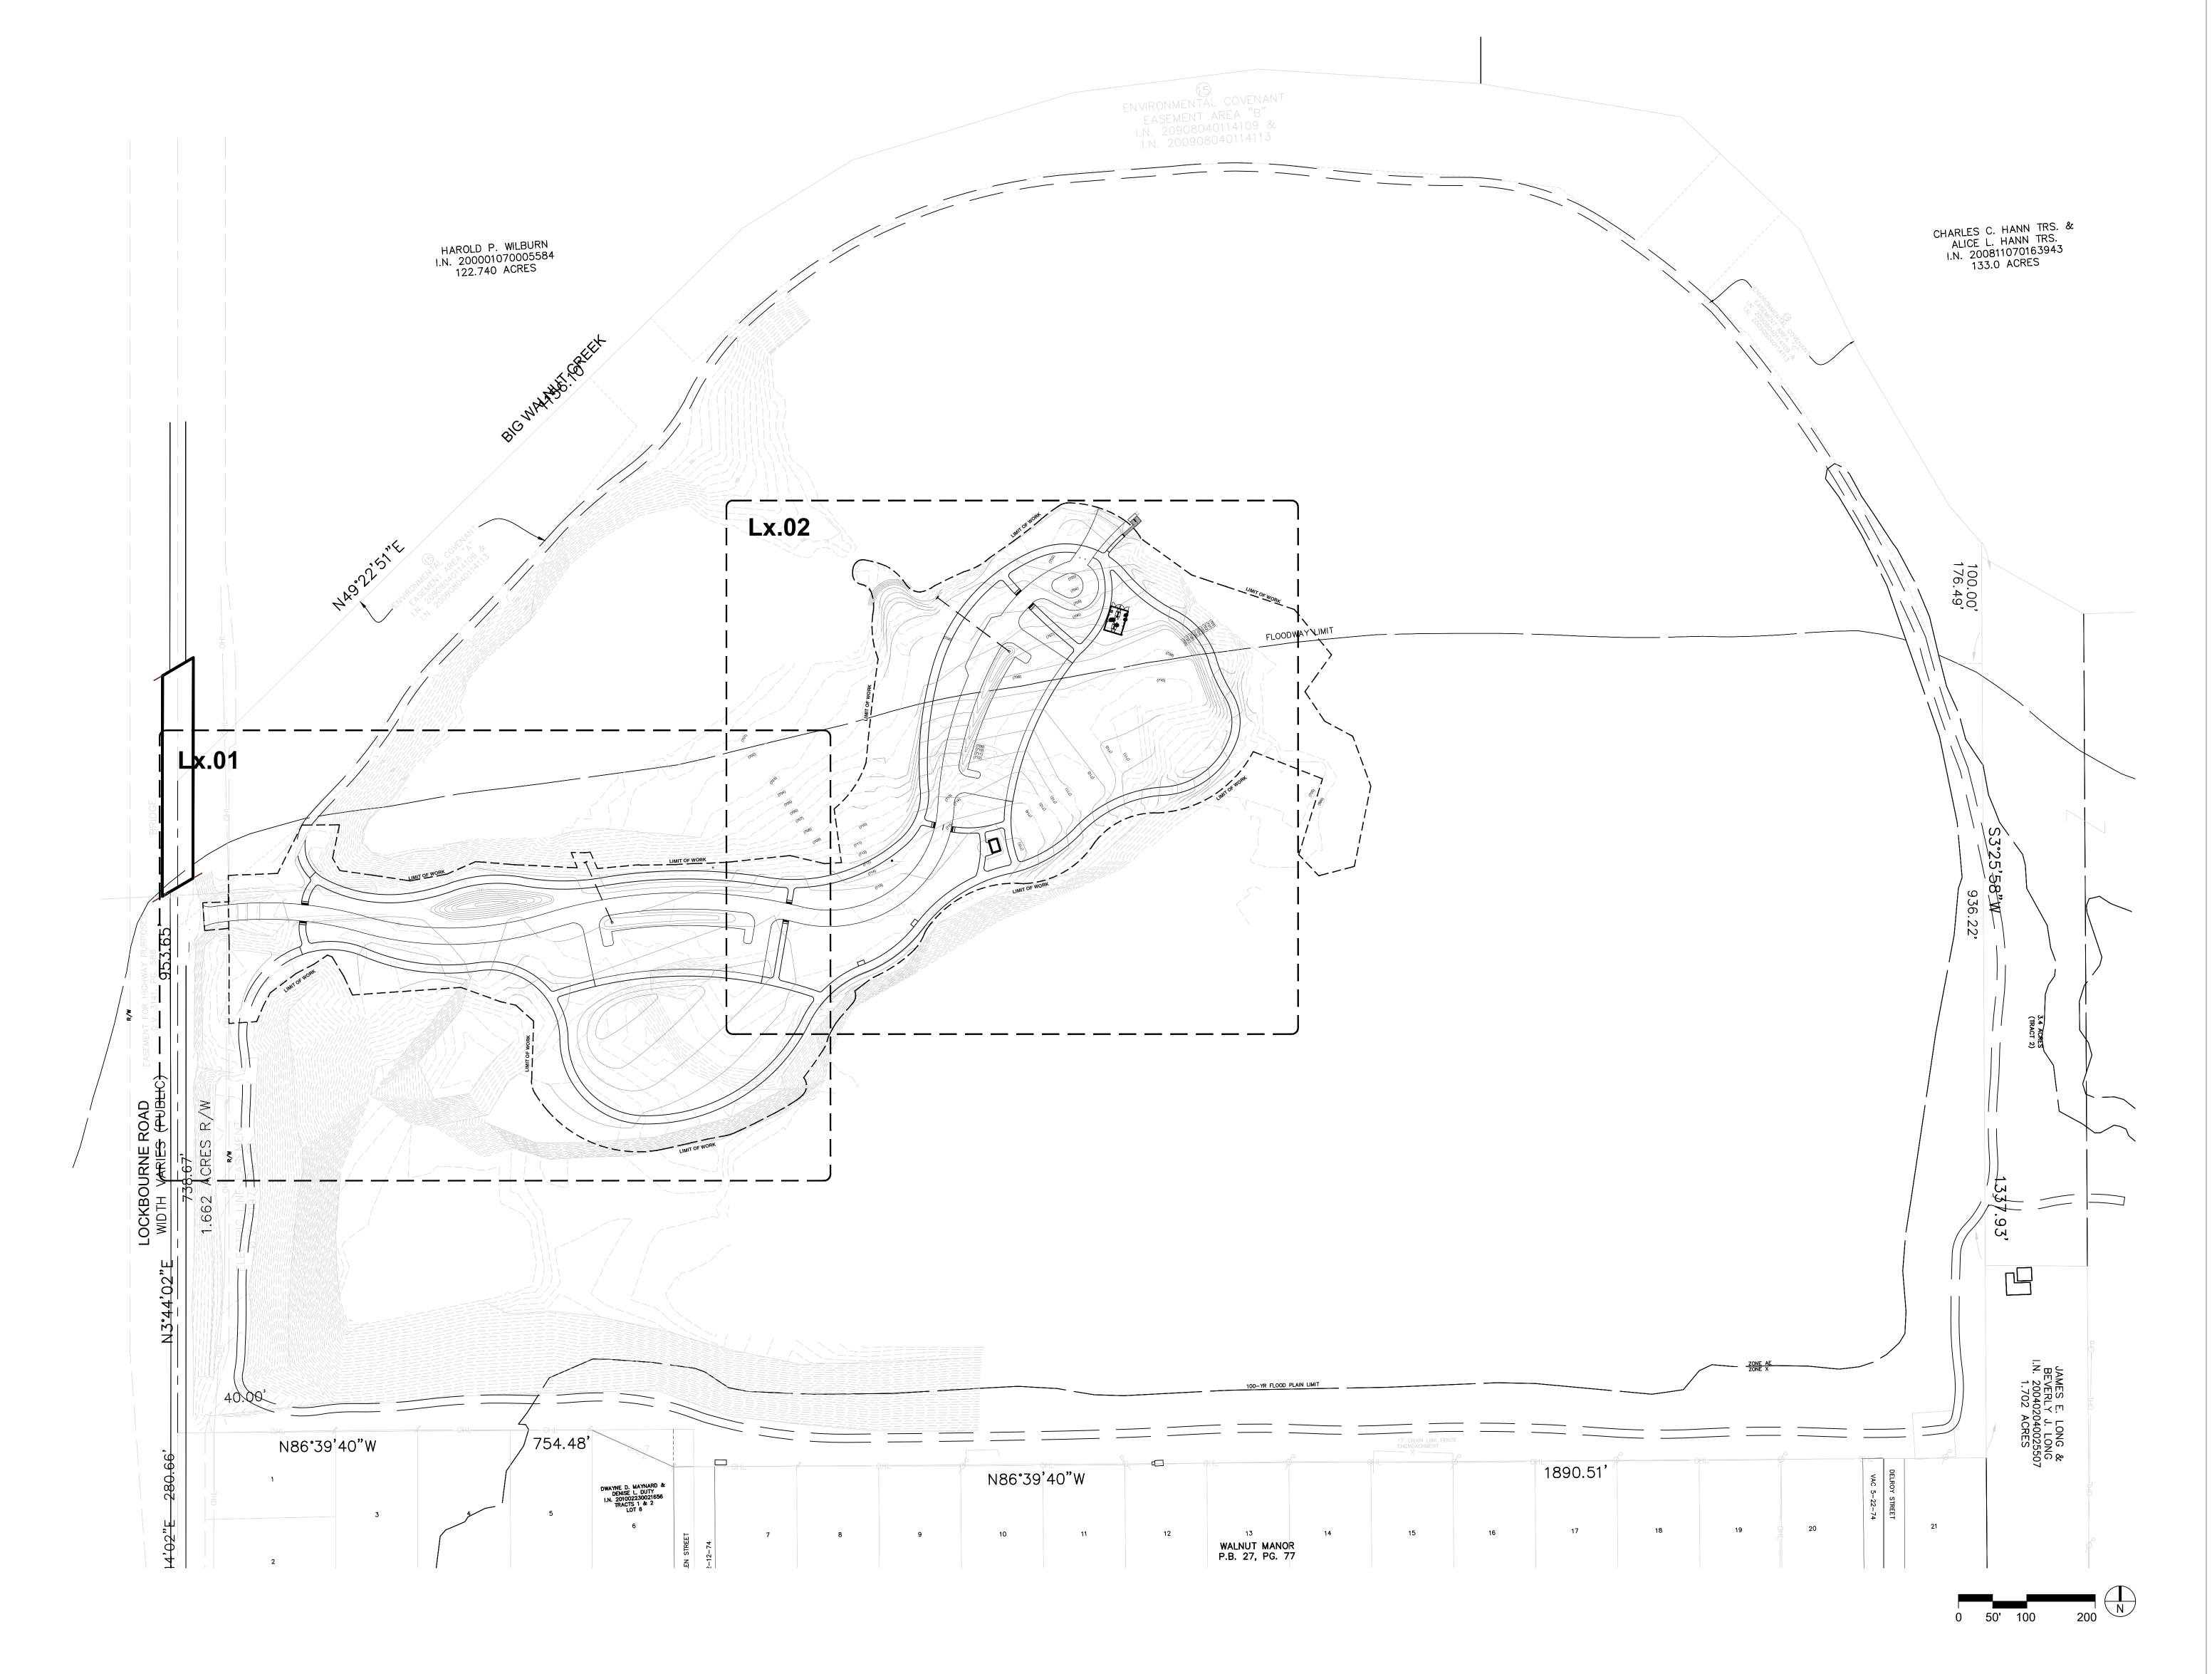
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issue date 10.31.2025

EXISTING SITE SURVEY



Landscape Architecture Urban Design **Planning**

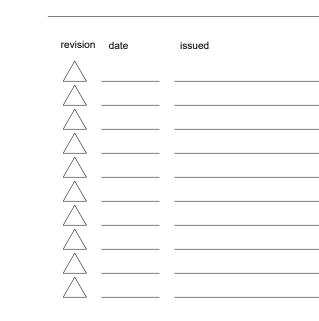
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client / owner COLUMBUS AND FRANKLIN COUNTY METRO PARKS project name

BANK RUN SITE **IMPROVEMENTS** PHASE ONE

project address 5636 LOCKBOURNE RD, LOCKBOURNE, OH 43137

100% CONSTRUCTION DOCUMENTS



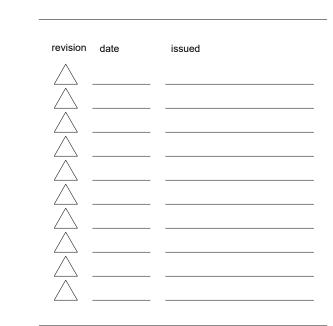

issue date 10.31.2025

OVERALL SITE & KEY PLAN sheet number

STORMWATER POLLUTION PREVENTION PLAN NOTES:

- 1. CONSTRUCT IN ACCORDANCE WITH THESE PLANS, & ODNR 'RAINWATER AND LAND DEVELOPMENT' 2006 EDITION. THE IMPLEMENTATION OF SOIL EROSION AND SEDIMENT CONTROL SHALL ALSO CONFORM TO THE REQUIREMENTS OF THE OHIO ENVIRONMENTAL PROTECTION AGENCY (OEPA) UNDER NPDES PERMIT #XXXXXXXX. IF CONFLICTS EXIST REGARDING THE SOIL AND SEDIMENT CONTROL PRACTICES, THE MORE RESTRICTIVE SHALL FOLLOWED. APPLY.
- 2. STABILIZATION OF DISTURBED AREAS: DISTURBED AREAS SHALL HAVE SOIL STABILIZATION APPLIED WITHIN SEVEN (7) DAYS IF THEY ARE TO REMAIN DORMANT (UNDISTURBED) FOR MORE THAN FOURTEEN (14) DAYS. FOR AREAS WITHIN FIFTY (50) FEET OF ANY LIVE STREAM OR WETLAND AND NOT AT FINAL GRADE, SOIL STABILIZATIÓN PRACTICES SHALL BE INITIATED WITHIN TWO (2) DAYS ON ALL INACTIVE, DISTURBED AREAS. PERMANENT OR TEMPORARY SOIL STABILIZATION SHALL BE APPLIED TO DISTURBED AREAS WITHIN SEVEN (7) DAYS AFTER FINAL GRADE IS REACHED ON ANY PORTION OF THE SITE. WHEN SEASONAL CONDITIONS PROHIBIT THE APPLICATION OF TEMPORARY OR PERMANENT SEEDING, NON-VEGETATIVE SOIL STABILIZATION PRACTICES SUCH AS MULCHING AND MATTING SHALL BE USED. TEMPORARY SEEDING SHALL BE APPLIED WITH 2 TONS OF STRAW MULCH PER ACRE.
- 3. INSTALL ALL EROSION CONTROL ITEMS BEFORE ANY CLEARING AND GRUBBING OR EARTHWORK IS BEGUN AND MAINTAIN UNTIL UPLAND AREAS ARE STABILIZED.
- 4. PROTECT UNDISTURBED AREAS THROUGHOUT CONSTRUCTION. DO NOT STORE EQUIPMENT, VEHICLES OR MATERIALS IN THESE PROTECTED AREAS.
- 5. SEEDING AND MULCHING FOR PERMANENT COVER SHALL BE AS SPECIFIED.
- 6. FERTILIZATION SHALL BE AS SPECIFIED.
- 7. TOPSOILING SHALL BE AS SPECIFIED.
- 8. SILT FENCE AND WATTLE SHALL BE AS SPECIFIED.
- 9. ROCK CHANNEL PROTECTION SHALL BE AS SPECIFIED.
- 10. NO SOLID OR LIQUID WASTE SHALL BE DISCHARGED INTO STORMWATER RUNOFF.
- 11. OFF-SITE VEHICLE TRACKING OF SEDIMENTS WILL BE MINIMIZED.
- 12. OTHER EROSION CONTROL ITEMS MAY BE NECESSARY DUE TO ENVIRONMENTAL AND SITE CONDITIONS. THE CONTRACTOR IS TO PROVIDE THESE MEASURES AT NO ADDITIONAL COST.
- 13. EROSION CONTROL MATTING AS SPECIFIED SHALL BE USED ON DITCHES WITH GRADES GREATER THAN 1.5% AND ALL OTHER SLOPES GREATER THAN 6% OR WHERE SHOWN ON THE PLANS.
- 14. ALL EROSION AND SEDIMENT CONTROL PRACTICES MUST MEET STANDARDS AND SPECIFICATIONS OF THE OHIO RAINWATER AND LAND DEVELOPMENT HANDBOOK (2006).
- 15. ALL CONSTRUCTION AND DEMOLITION DEBRIS (C&DD) WASTE WILL BE DISPOSED OF FERTILIZERS THE MANUFACTURE'S RECOMMENDED MINIMAL AMOUNTS SHALL BE APPLIED IN AN OHIO EPA APPROVED C&DD LANDFILL AS REQUIRED BY OHIO REVISED CODE (ORC) 3714 AND LOCAL REGULATIONS.

16. MAINTENANCE AND INSPECTION:

CONTRACTOR SHALL COMPLETE THE SITE INSPECTION REPORTS TO PERMANENTLY RECORD MAINTENANCE AND INSPECTION OF ALL EROSION PREVENTION AND CONTROL METHODS IMPLEMENTED ON THE SITE. THE REPORTS SHALL BE COMPLETED ONCE EVERY 21. SUGGESTED GENERAL SEQUENCE OF CONSTRUCTION SEVEN DAYS AND AFTER STORM EVENTS GREATER THAN 0.5 INCHES IN A TWENTY-FOUR CONSTRUCTION SHALL NOT BEGIN UNTIL ALL SEDIMENT AND EROSION CONTROL HOUR PERIOD. CONTRACTOR SHALL SUBMIT SIGNED REPORTS TO THE PROJECT MANAGER ON A WEEKLY BASIS. THE PROJECT MANAGER/OWNER WILL INSPECT THE PROJECTS EROSION PREVENTION AND CONTROL METHODS IMPLEMENTED ON THE SITE AGAINST THE REPORTS OF THE CONTRACTOR. ANY DISCREPANCIES BETWEEN THE REPORTS AND THE ACTUAL FIELD CONDITIONS WILL BE BROUGHT TO THE ATTENTION OF • MOBILIZE; THE CONTRACTOR FOR IMMEDIATE CORRECTION. ITEMS NOT CORRECTED WITHIN A 48 HOUR PERIOD WILL BE CORRECTED, AT THE OWNERS DISCRETION, BY A THIRD PARTY

INSTALL EROSION AND SEDIMENT CONTROLS; CONTRACTOR AND THE COST FOR SUCH WORK WILL BE BILLED DIRECTLY BACK TO THE CONTRACTOR.

17. REPAIRS:

ANY EROSION CONTROL MEASURES, STRUCTURES, DEVICES, OR RELATED ITEMS IN NEED OF REPAIR WILL BE MADE WITHIN 24 HOURS.

18. WINTERIZATION:

ANY DISTURBED AREA THAT IS NOT GOING TO BE WORKED ON FOR 14 DAYS OR MORE MUST BE SEEDED & MULCHED BY NOVEMBER 1, OR MUST HAVE A DORMANT SEEDING OR MULCH COVER APPLIED BETWEEN NOVEMBER 1 AND MARCH 1.

19. MATERIAL MANAGEMENT PRACTICES:

THE FOLLOWING PRACTICES SHALL BE EXECUTED TO REDUCE THE RISK OF SPILLS OR OTHER ACCIDENTAL EXPOSURE OF MATERIALS AND SUBSTANCES TO STORMWATER RUN-OFF. THE JOB SITE SUPERINTENDENT IS RESPONSIBLE FOR ENSURING THESE PRACTICES ARE

- STORE THE MINIMUM AMOUNT OF PRODUCT REQUIRED TO COMPLETE THE JOB, IF POSSIBLE, UNDER ROOF OR IN A CONTAINMENT AREA. PRODUCTS SHALL REMAIN IN THEIR ORIGINAL CONTAINER. LABEL MUST BE LEGIBLE.
- MANUFACTURER'S RECOMMENDATION SHALL BE FOLLOWED FOR USE AND DISPOSAL.
- PRODUCT TO BE USED ENTIRELY (WHEN POSSIBLE) PRIOR TO DISPOSING.
- MATERIAL SAFETY DATA SHEETS (MSDS) FOR EACH SUBSTANCE WITH HAZARDOUS PROPERTIES USED ON THE SITE SHALL BE OBTAINED AND POSTED IN THE IMMEDIATE AREA OF PRODUCT STORAGE AND SHALL BE USED FOR PROPER MANAGEMENT OF POTENTIAL WASTE.
- ALL HAZARDOUS WASTE MATERIAL WILL BE DISPOSED BY THE CONTRACTOR IN A MANNER SPECIFIED BY LOCAL, STATE OR FEDERAL REGULATIONS AND PER MANUFACTURERS RECOMMENDATIONS.
- ALL PERSONNEL SHALL BE TRAINED IN THE PROPER HANDLING AND CLEAN UP OF SPILLED MATERIALS. NO SPILLED HAZARDOUS MATERIALS OR WASTE SHALL BE ALLOWED TO COME IN CONTACT WITH STORMWATER DISCHARGES. IF NECESSARY, THE CONTAMINATED STORMWATER WILL BE HELD ON SITE UNTIL IT MEETS LOCAL, STATE AND FEDERAL REGULATIONS.
- IN THE EVENT OF A SPILL THE FOLLOWING PROCEDURES MUST BE FOLLOWED:
 - ALL SPILLS SHALL BE CLEANED UP IMMEDIATELY AFTER DISCOVERY.
 - THE PROJECT MANAGER AND ENGINEER OF RECORD IMMEDIATELY NOTIFIED.
 - ANY SPILLS OF TOXIC OR HAZARDOUS MATERIALS MUST BE REPORTED TO THE APPROPRIATE LOCAL, STATE AND FEDERAL AGENCY. THE EPA NATIONAL RESPONSE CENTER (1-800-424-8802) MUST BE NOTIFIED WHEN A SPILL EXCEEDS THE REPORTABLE QUANTITY OF A SUBSTANCE. THE SUBSTANCES AND AMOUNTS ARE LOCATED IN FEDERAL REGULATIONS (40 CFR 110, 114 AND 302).
 - IF A SPILL EXCEEDS A REPORTABLE QUANTITY, THE SWPP MUST BE MODIFIED WITHIN 7 DAYS PROVIDING A DESCRIPTION, DATE AND INCIDENT OF THE RELEASE.

20. PRODUCT SPECIFIC PRACTICES:

<u>PETROLEUM</u> — PETROLEUM PRODUCTS WILL BE STORED IN CLEARLY LABELED TIGHTLY SEALED CONTAINERS. ANY ON SITE PETROLEUM STORAGE TANKS WILL HAVE A CONTAINMENT STRUCTURE AROUND IT FOR POTENTIAL SPILLS. DRIP PANS SHALL BE PROVIDED FOR ALL DISPENSERS. MANUFACTURERS RECOMMENDATIONS SHALL BE FOLLOWED WHEN ANY ASPHALT SUBSTANCES ARE USED ON SITE.

AND WORKED INTO THE SOIL TO LIMIT THE EXPOSURE TO STORMWATER. THE CONTENTS OF ANY PARTIALLY USED BAGS WILL BE TRANSFERRED TO SEALABLE PLASTIC BINS AND STORED UNDER COVER, AWAY FROM STORMWATER DRAINAGE WAYS.

<u>CONCRETE</u> - TRUCK WASH OUT AND DISCHARGE OF SURPLUS WASH WATER ON SITE IS PERMITTED EXCLUSIVELY IN THE DESIGNATED AREA.

MEASURES HAVE BEEN INSTALLED. THE CONTRACTOR SHALL MINIMIZE DISTURBANCE WITHIN THE WORKING AREA WHEREVER POSSIBLE.

- CONSTRUCT TEMPORARY ACCESS ROADS AND STAGING AREAS; INSTALL PERIMETER SEDIMENT CONTROLS AROUND STAGING AREA;
- TREE STUMP AND VEGETATION CLEARING AND GRUBBING;
- SITE LAYOUT;
- STRIP AND STOCKPILE TOPSOIL;
- INSTALL EROSION AND SEDIMENT CONTROLS AS AREAS BECOME DISTURBED;
- BEGIN EARTHMOVING CUT AND FILL ACTIVITIES TO ACHIEVE SUBGRADE;
- SEED AND STRAW ANY DISTURBED AREAS;

• INSTALL UTILITIES, AND GRADE;

- INSTALL INFRASTRUCTURE IMPROVEMENTS;
- PLACE AND RESPREAD TOPSOIL TO FINISH GRADE;
- FINAL SEED, STABILIZE, AND INSTALL EROSION CONTROL FABRIC AND SWPPP
- REMOVE TEMPORARY EROSION AND SEDIMENT CONTROLS ONCE 70% STABILIZATION OF DISTURBED AREAS HAS BEEN ACHIEVED;
- DEMOBILIZE.

22. DUST CONTROL

- VEGETATIVE COVER AND MULCH APPLY TEMPORARY OR PERMANENT SEEDING AND MULCH TO AREA THAT WILL REMAIN IDLE FOR OVER 21 DAYS. TO THE EXTENT POSSIBLE, EXISTING TREES AND LARGE SHRUBS SHALL REMAIN IN PLACE TO REDUCE SOIL AND AIR MOVEMENT ACROSS DISTURBED AREAS. SEE TEMPORARY SEEDING, PERMANENT SEEDING, • AND MULCHING PRACTICES.
- WATERING SPRAY SITE WITH WATER UNTIL THE SURFACE IS WET BEFORE AND DURING GRADING AND REPEAT AS NEEDED TO PREVENT GENERATION OF VISIBLE AIRBORNE DUST. ESPECIALLY ON HAUL ROADS AND OTHER HEAVY TRAFFIC ROUTE. WATERING SHALL BE DONE AT A RATE THAT PREVENTS DUST BUT DOES NOT CAUSE SOIL EROSION. WETTING AGENTS SHALL BE UTILIZED ACCORDING TO MANUFACTURERS INSTRUCTIONS. CHEMICAL AND ORGANIC AGENTS SHOULD NOT BE APPLIED UNDER FROZEN CONDITIONS, RAINY CONDITIONS, OR WHEN THE TEMPERATURE IS BELOW 40° F. THESE AGENTS WILL NOT BE USED IN THE FLOODPLAIN.
- SPRAY-ON ADHESIVES APPLY ADHESIVE ACCORDING TO THE TABLE PROVIDED OR MANUFACTURERS INSTRUCTIONS. ADHESIVES WILL NOT BE USED IN THE FLOODPLAIN.
- STONE GRADED ROADWAYS AND OTHER SUITABLE AREAS WILL BE STABILIZED USING CRUSHED STONE OR COARSE GRAVEL AS SOON AS PRACTICAL AFTER REACHING AN INTERIM OR FINAL GRADE. CRUSHED STONE OR COARSE GRAVEL CAN BE USED AS A PERMANENT COVER TO PROVIDE CONTROL OF SOIL EMISSIONS.
- BARRIERS EXISTING WINDBREAK VEGETATION SHALL BE MARKED AND PRESERVED. SNOW FENCING OR OTHER SUITABLE BARRIER MAY BE PLACED PERPENDICULAR TO PREVAILING AIR CURRENTS AT INTERVALS OF ABOUT 15 TIMES THE BARRIER HEIGHT TO CONTROL AIR CURRENTS AND BLOWING SOIL. THIS MATERIAL WILL NOT BE USED IN THE FLOODPLAIN.
- CALCIUM CHLORIDE THIS CHEMICAL MAY BE APPLIED BY MECHANICAL SPREADER AS LOOSE, DRY GRANULES OR FLAKES AT A RATE THAT KEEPS THE SURFACE MOIST BUT NOT SO HIGH AS TO CAUSE WATER POLLUTION OR PLANT DAMAGE. APPLICATION RATES SHOULD BE STRICTLY IN ACCORDANCE WITH SUPPLIERS SPECIFIED RATES. THIS MATERIAL WILL NOT BE USED IN THE FLOODPLAIN.
- OPERATION AND MAINTENANCE SITE SHALL BE CONTINUOUSLY MONITORED TO VERIFY EFFECTIVENESS OF DUST CONTROL MEASURES. WHEN TEMPORARY DUST CONTROL MEASURES ARE USED, REPETITIVE TREATMENT SHOULD BE APPLIED AS NEEDED TO ACCOMPLISH CONTROL.

23. VOLUMETRIC RUN-OFF COEFFICIENT

- TOTAL DISTURBED SITE AREA X.XX AC
- EXISTING SITE IMPERVIOUS AREA <u>X.XX AC (X.XXX)</u>
 - EXISTING VOLUMETRIC RUN-OFF COEFFICIENT (R1) R1 = 0.05 + 0.9(X.XXX)R1 = X.XXX
- PROPOSED SITE IMPERVIOUS AREA X.XX AC (X.XXX)
 - PROPOSED VOLUMETRIC RUN-OFF COEFFICIENT (R2) R2 = 0.05 + 0.9(X.XXX)R2 = X.XXX
- $\left[\frac{X.XXX(R2)}{X.XXX(R1)}\right] 100\% = \frac{X.XX\%}{REDUCTION}$
- 24. TOPSOIL REPLACEMENT TOPSOIL REPLACEMENT IS REQUIRED FOR ALL SITE PERVIOUS AREAS WHERE THE SOIL WAS GRADED OR COMPACTED.
- PRESERVE OR PROTECT THE NATURAL SOIL PROFILE DURING AND FOLLOWING CONSTRUCTION:
- REMOVE AND STOCKPILE TOPSOIL BEFORE ANY GRADING; POST GRADING, THE SUBGRADE SHOULD BE TILLED TO A DEPTH OF 6 INCHES AND 6 INCHES OF TOPSOIL REPLACED (WITHOUT COMPACTION);
- THE TOPSOIL MUST MEET THE FOLLOWING SPECIFICATIONS:
- TOPSOIL MUST HAVE MINIMUM 6"DEPTH OF LOOSE, FRIABLE SOIL
- TOPSOIL TEXTURE -LOAM, SILT LOAM OR SANDY LOAM TEXTURE
- CLAY CONTENT MUST BE LESS THAN 20%
- ORGANIC MATTER CONTENT MUST BE >5% (BY WEIGHT) DETERMINE BY LOSS-ON-IGNITION OR EQUIVALENT TEST
- BULK DENSITY THE DRY, SETTLED (I.E., AFTER PLACEMENT AND WETTING) BULK DENSITY MUST BE WITHIN THE FOLLOWING RANGES:

SOIL TEXTURE	DRY BULK DENSITY (SETTLED)
	G/CM ³ (LB/FT ³)
SILT LOAM	1.20 -1.35 (75.0 -85.0)
LOAM	1.25 -1.40 (78.0 -87.5)
SANDY LOAM	1.30 -1.45 (81.0 -90.5)

- THE SOIL PROFILE TO A DEPTH OF 12" MUST HAVE PENETRATION RESISTANCE LESS THAN 200 PSI (1.4 MPA)

[AS MEASURED BY A CONE PENETROMETER INSERTED AT 0.8 IN/S (2 CM/S)] (ASABE, 1999)

- THE AREA SHOULD BE IMMEDIATELY SEEDED OR PLANTED IN AS SPECIFIED. STRAW MULCH OR EROSION CONTROL BLANKETS SHOULD BE USED AS SPECIFIED TO PROTECT THE SOIL UNTIL VEGETATION MATURES.
- TOPSOIL REPLACEMENT IS ESTABLISHED. CONSIDERED COMPLETE WHEN VEGETATIVE COVER IS 90%

INSPECTION CHECKLIST

INSPECTIONS SHALL BE MADE ONCE EVERY SEVEN (7) CALENDAR DAYS, PRIOR TO ANY FORECASTED RAIN ENVENT OF 0.25 INCHES OR GREATER, AND WITHIN 24 HOURS AFTER ANY STORM EVENT GREATER THAN ONE-HALF INCH OF RAIN PER 24 HOUR PERIOD.

DATE	INSPECTOR	WEATHER CONDITIONS	RAINFALL AMOUNT	SEDIMENT DISCHARGE	WEATHER CONDITIONS	BMPS FAILED	ADDITIONAL BMPS NEEDED	CORECTION MADE

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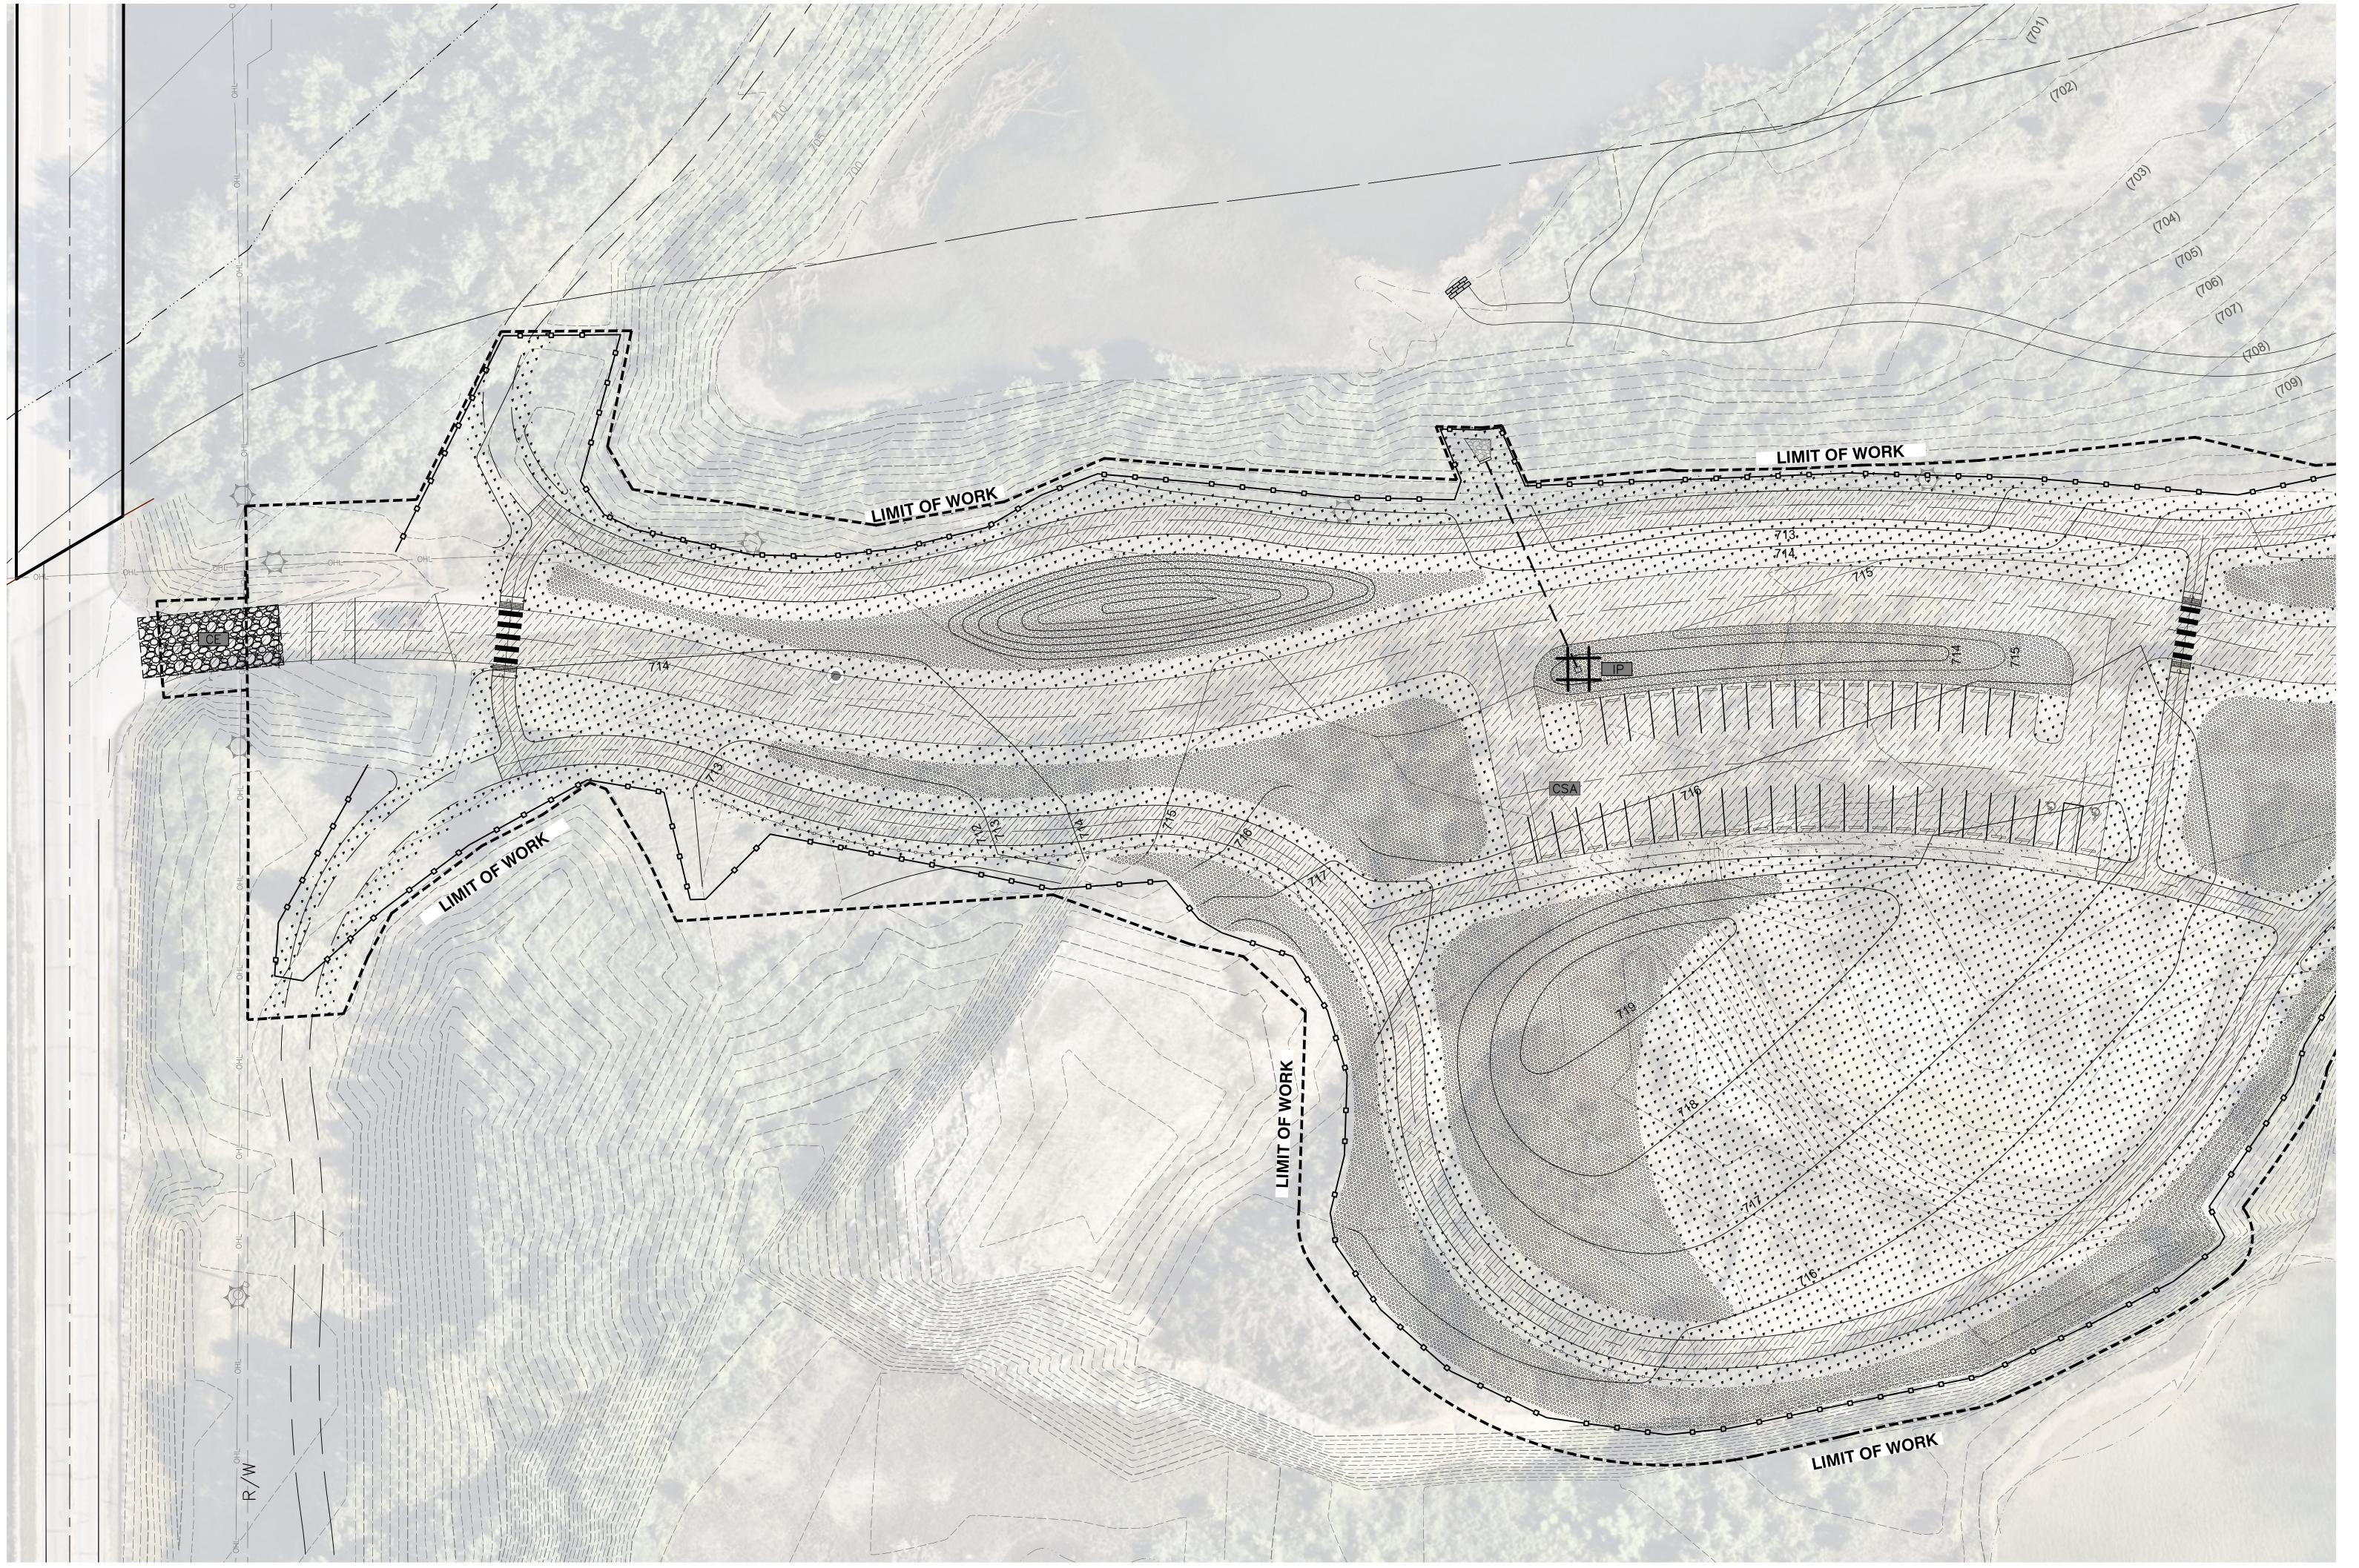
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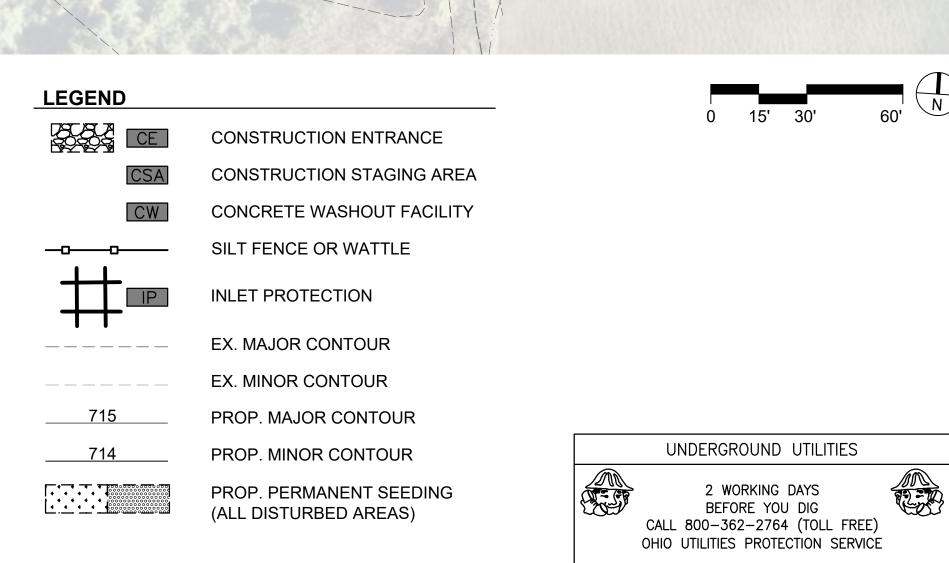


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SEDIMENT AND EROSION

CONTROL NOTES





NON-MEMBERS MUST BE CALLED DIRECTLY MKSK

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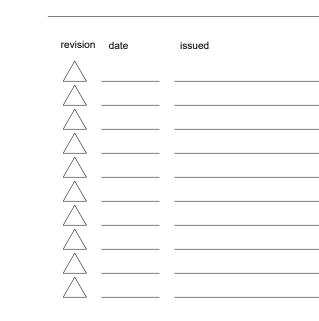
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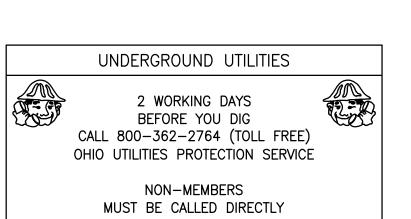
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project number c25114

SEDIMENT AND EROSION CONTROL PLAN



CE CONSTRUCTION ENTRANCE CSA CONSTRUCTION STAGING AREA CW CONCRETE WASHOUT FACILITY SILT FENCE OR WATTLE INLET PROTECTION EX. MAJOR CONTOUR EX. MINOR CONTOUR PROP. MAJOR CONTOUR 714 PROP. MINOR CONTOUR PROP. PERMANENT SEEDING (ALL DISTURBED AREAS)



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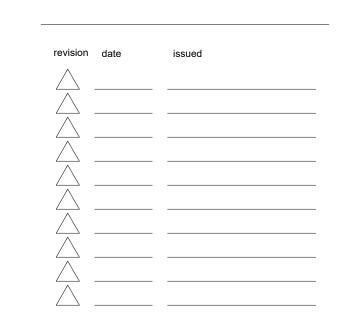
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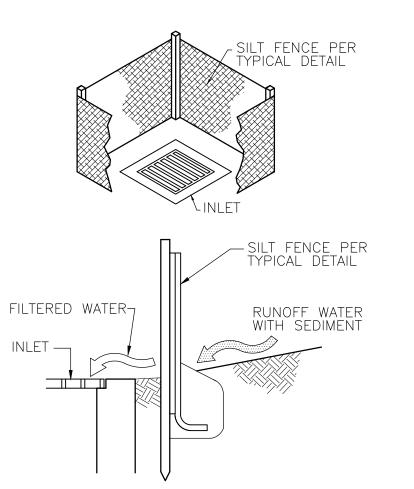






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SEDIMENT AND EROSION
CONTROL PLAN
sheet number


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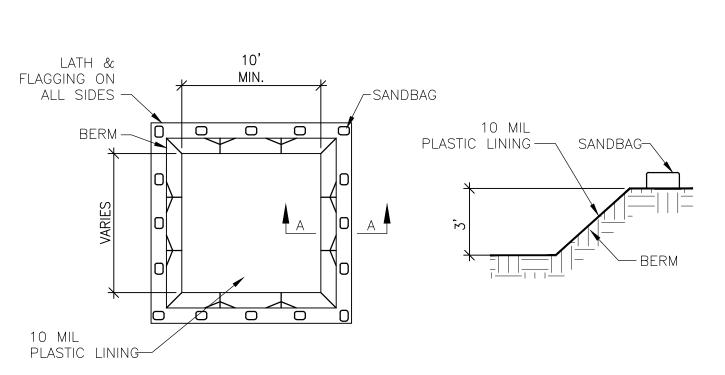




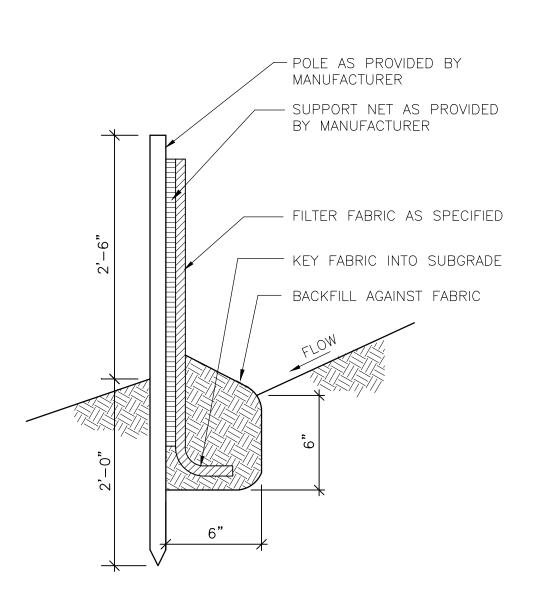

SWALE EROSION PROTECTION NOT TO SCALE

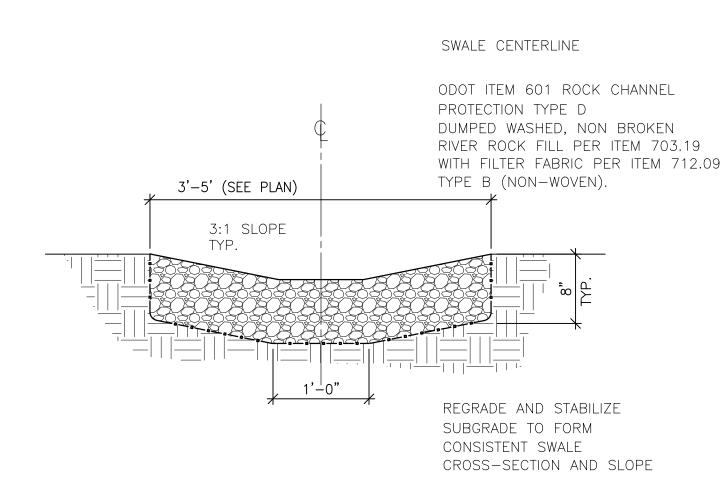

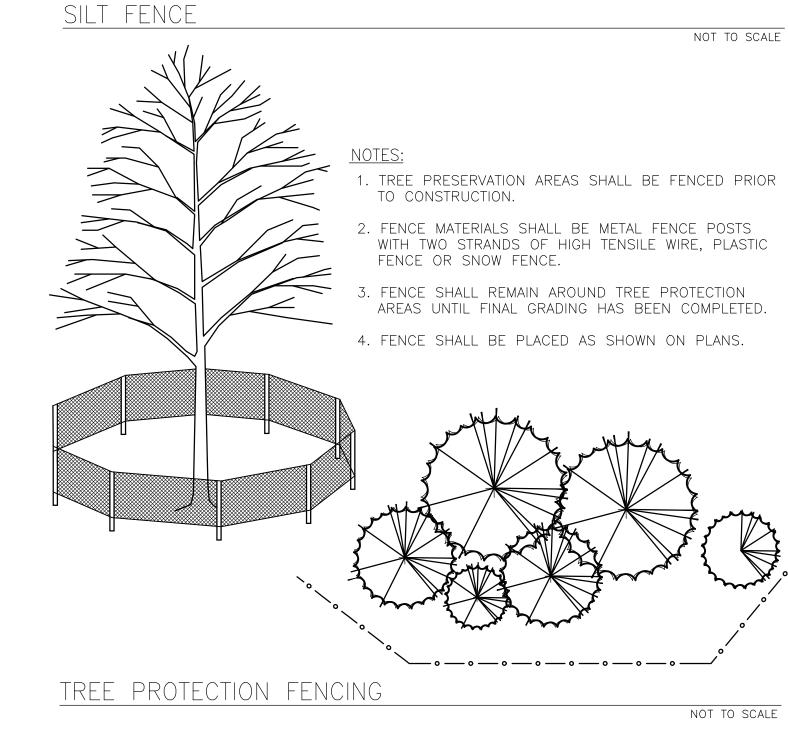

TEMPORARY CONCRETE WASHOUT FACILITIES SHOULD BE CONSTRUCTED AS SHOWN ON THE DETAIL, WITH A RECOMMENDED MINIMUM LENGTH AND WIDTH OF 10 FT. THE VOLUME SHOULD BE SUFFICIENT TO CONTAIN ALL LIQUID AND CONCRETE WASTE GENERATED BY WASHOUT OPERATIONS.

2. LATH AND FLAGGING SHOULD BE COMMERCIAL TYPE.

3. PLASTIC LINING MATERIAL SHOULD BE A MINIMUM OF 10 MIL POLYETHYLENE SHEETING AND 11. REMOVAL——THE ENTRANCE SHALL REMAIN IN PLACE UNTIL THE DISTURBED AREA IS SHOULD BE FREE OF HOLES, TEARS, OR OTHER DEFECTS THAT COMPROMISE THE STABILIZED OR REPLACED WITH A PERMANENT ROADWAY OR ENTRANCE. SHOULD BE FREE OF HOLES, TEARS, OR OTHER DEFECTS THAT COMPROMISE THE IMPERMEABILITY OF THE MATERIAL.

CONCRETE WASHOUT PIT

NOT TO SCALE

70 FT. (30 FT. FOR ACCESS TO INDIVIDUAL HOUSE LOT) 14 FT. MINIMUM AND NOT LESS THAN WIDTH OF INGRESS/EGRESS RIGHT OF WAY DIVERSION AS NEEDED ROAD OR OTHER PAVED SURFACES 18" OR SUFFICIENT CULVERT AS NEEDED TO DIVERT RUNOFF

- 1. STONE SIZE——ODOT #2 (1.5 2.5 INCH) STONE SHALL BE USED, OR RECYCLED CONCRETE PAVEMENT.
- HIGH TRAFFIC AREAS BUT NOT LESS THAN 70 FT. (EXCEPTION: APPLY 30 FT. MINIMUM TO SINGLE RESIDENCE LOT).

2. LENGTH——THE CONSTRUCTION ENTRANCE SHALL BE AS LONG AS REQUIRED TO STABILIZE


- 3. THICKNESS--THE STONE LAYER SHALL BE AT LEAST 6-IN. THICK FOR LIGHT DUTY ENTRANCES OR AT LEAST 10-IN. FOR HEAVY DUTY USE.
- 4. WIDTH--THE ENTRANCE SHALL BE AT LEAST 14-FT. WIDE, BUT LESS THAN THE FULL WIDTH AT POINTS WHERE INGRESS OR EGRESS OCCURS.

5. GEOTEXTILE——A GEOTEXTILE SHALL BE LAID OVER THE ENTIRE AREA PRIOR TO PLACING STONE. IT SHALL BE COMPOSED OF STRONG ROT—PROOF POLYMERIC FIBERS AND MEET THE FOLLOWING SPECIFICATIONS:

MINIMUM TENSILE STRENGTH	200 LBS.
MINIMUM PUNCTURE STRENGTH	80 PSI
MINIMUM TEAR STRENGTH	50 LBS.
MINIMUM BURST STRENGTH	320 PSI
MINIMUM ELONGATION	20%
EQUIVALENT OPENING SIZE	EOS < 0.60 mm
PERMITTIVITY	1x10-3 CM/SEC


- 6. TIMING--THE CONSTRUCTION ENTRANCE SHALL BE INSTALLED AS SOON AS IS PRACTICABLE BEFORE MAJOR GRADING ACTIVITIES.
- 7. CULVERT——A PIPE OR CULVERT SHALL BE CONSTRUCTED UNDER THE ENTRANCE IF NEEDED TO PREVENT SURFACE WATER FLOWING ACROSS THE ENTRANCE OR TO PREVENT RUNOFF FROM BEING DIRECTED OUT ONTO PAVED SURFACES.
- 8. WATER BAR——A WATER BAR SHALL BE CONSTRUCTED AS PART OF THE CONSTRUCTION ENTRANCE IF NEEDED TO PREVENT SURFACE RUNOFF FROM FLOWING THE LENGTH OF THE CONSTRUCTION ENTRANCE AND OUT ONTO PAVED SURFACES.
- 9. MAINTENANCE——TOP DRESSING OF ADDITIONAL STONE SHALL BE APPLIED AS CONDITIONS DEMAND. MUD SPILLED, DROPPED, WASHED OR TRACKED ONTO PUBLIC ROADS, OR ANY SURFACE WHERE RUNOFF IS NOT CHECK BY SEDIMENT CONTROLS, SHALL BE REMOVED IMMEDIATELY. REMOVAL SHALL BE ACCOMPLISHED BY SCRAPING OR SWEEPING.

CONSTRUCTION ENTRANCE NOT TO SCALE

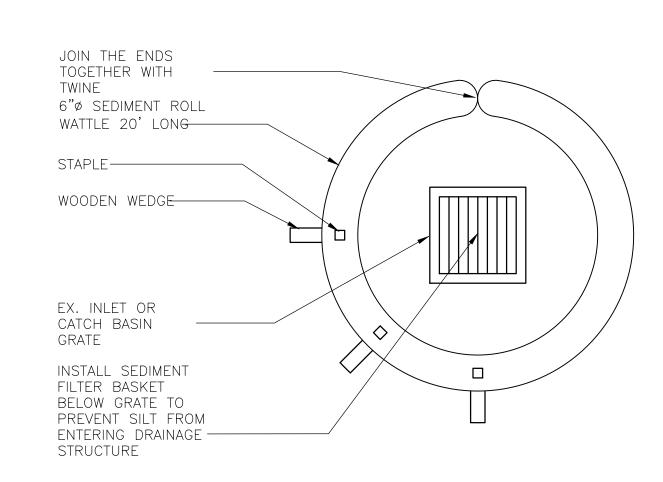

1. SEDIMENT ROLL WATTLES AND FILTER BASKETS SHALL BE INSTALLED AND MAINTAINED AROUND STORM SEWERS INLETS AS INDICATED ON PLAN.

- 2. SEDIMENT ROLL WATTLES SHALL BE PLACED WITH ENDS TIGHTLY ABUTTING THE ADJACENT SEDIMENT BARRIERS TO CREATE A CONTINUOUS BARRIER.
- 3. EACH SEDIMENT ROLL WATTLE SHALL BE STAPLED AT 3'O.C. STAPLES TO PENETRATE 6" TO 12" BELOW GRADE.
- 4. WOODEN WEDGES AND STAPLES AS PER MANUFACTURER'S PRODUCT INSTALLATION
- 5. FILTER BASKETS SHALL BE USED FOR SEDIMENT CONTROL.
- 6. WATTLES SHALL BE REMOVED WHEN THEY HAVE SERVED THEIR PURPOSE SO AS NOT TO BLOCK OR IMPEDE STORM FLOW OR DRAINAGE.
- INLET PROTECTION WATTLE NOT TO SCALE

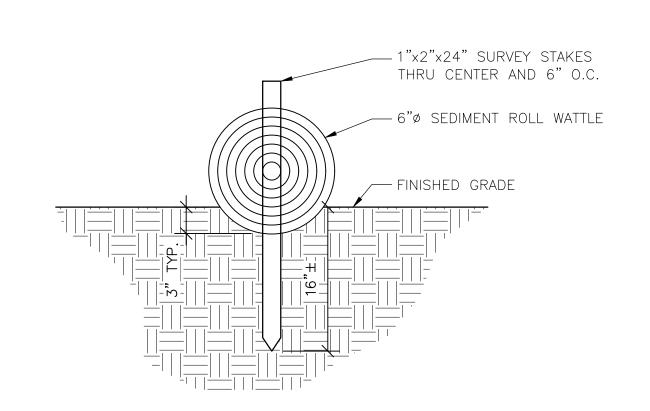

- 1. WATTLES SHALL BE PLACED IN A ROW WITH ENDS TIGHTLY ABUTTING.
- 2. EACH BALE SHALL BE EMBEDDED IN THE SOIL A MINIMUM OF 3 INCHES.
- 10. CONSTRUCTION ENTRANCES SHALL NOT BE RELIED UPON TO REMOVE MUD FROM VEHICLES
 AND PREVENT OFF—SITE TRACKING. VEHICLES THAT ENTER AND LEAVE THE
 CONSTRUCTION—SITE SHALL BE RESTRICTED FROM MUDDY AREAS.

 3. WATTLES SHALL BE SECURELY ANCHORED IN PLACE BY TWO STAKES OR RE—BARS DRIVEN
 THROUGH THE WATTLES. THE FIRST STAKE IN EACH BALE SHALL BE DRIVEN TOWARD THE
 PREVIOUSLY LAID BALE TO FORCE WATTLES TOGETHER.
 - 4. WATTLES SHALL BE REMOVED WHEN THEY HAVE SERVED THEIR PURPOSE SO AS NOT TO BLOCK OR IMPEDE STORM FLOW OR DRAINAGE.

NOT TO SCALE

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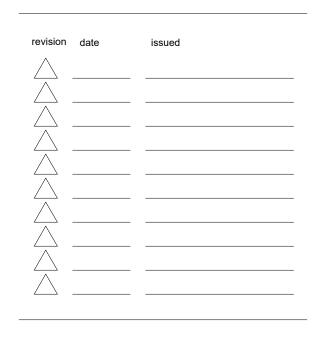
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SEDIMENT AND EROSION CONTROL DETAILS

CODED NOTES

- INSPECT AND REMOVE ALL VISIBLE REBAR FROM UNDERWATER CONCRETE SLABS. DEPTH OF CONCRETE SLAB VARIES.
- DEPTH OF CONCRETE SLAB VARIES.

 2 FREESTANDING 12" DIAMETER ROUND PIPE TO BE REMOVED.
- WOOD UTILITY POLE TO BE REMOVED, ANY EXISTING UTILITIES TO BE REMOVED AND TERMINATED AT NEAREST POLE TO RIGHT-OF-WAY.
- ASPHALT PAVEMENT AND ASSOCIATED BASE COURSE TO BE REMOVED AND HAULED OFFSITE.
- CONCRETE SPOILS AND HARDENED WASH OUT TO BE BROKEN UP IN-PLACE TO ALLOW FOR PERCOLATION. BACKFILL AND BRING TO PROPOSED GRADE WITH ON-SITE STOCKPILED SOIL.
- 6 CONCRETE JERSEY BARRIERS TO BE REMOVED AND HAULED OFFSITE. (TOTAL OF 14)
- CONCRETE PAD/PAVEMENT AND ASSOCIATED BASE COURSE TO BE REMOVED AND HAULED OFF-SITE.
- 8 EXISTING SPOILS OF CONSTRUCTION DEBRIS. ANY NON-CLEAN FILL AND/OR USEABLE AGGREGATE TO BE REMOVED AND HAULED OFF SITE.

- 9 METAL SIGN POSTS TO BE REMOVED AND ANY ASSOCIATED FOOTINGS.
- (10) EXISTING RESTROOM BUILDING TO REMAIN. PROTECT FROM DEMOLITION ACTIVITIES.
- 11 EXISTING UTILITY POLES TO REMAIN.
- EXISTING UTILITY POLE AND TRANSFORMER TO REMAIN.

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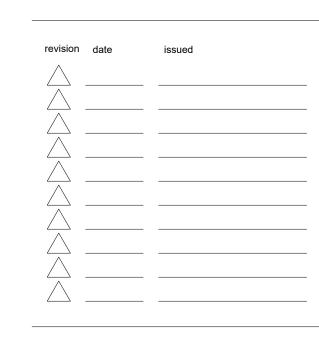
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SITE DEMOLITION

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CODED NOTES

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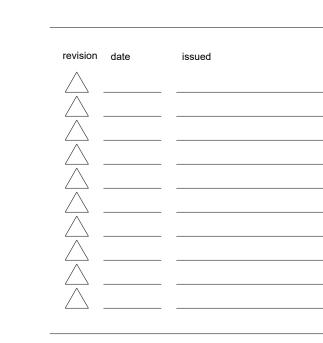
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SITE DEMOLITION

L2

REFER SPECIFICATIONS

PER PLAN & SPECIFICATIONS

MEADOW MIX

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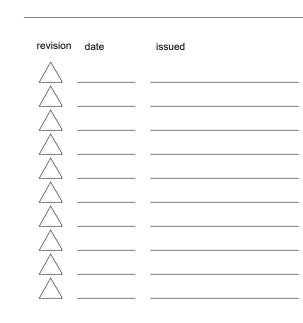
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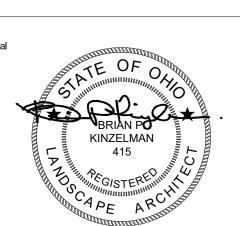
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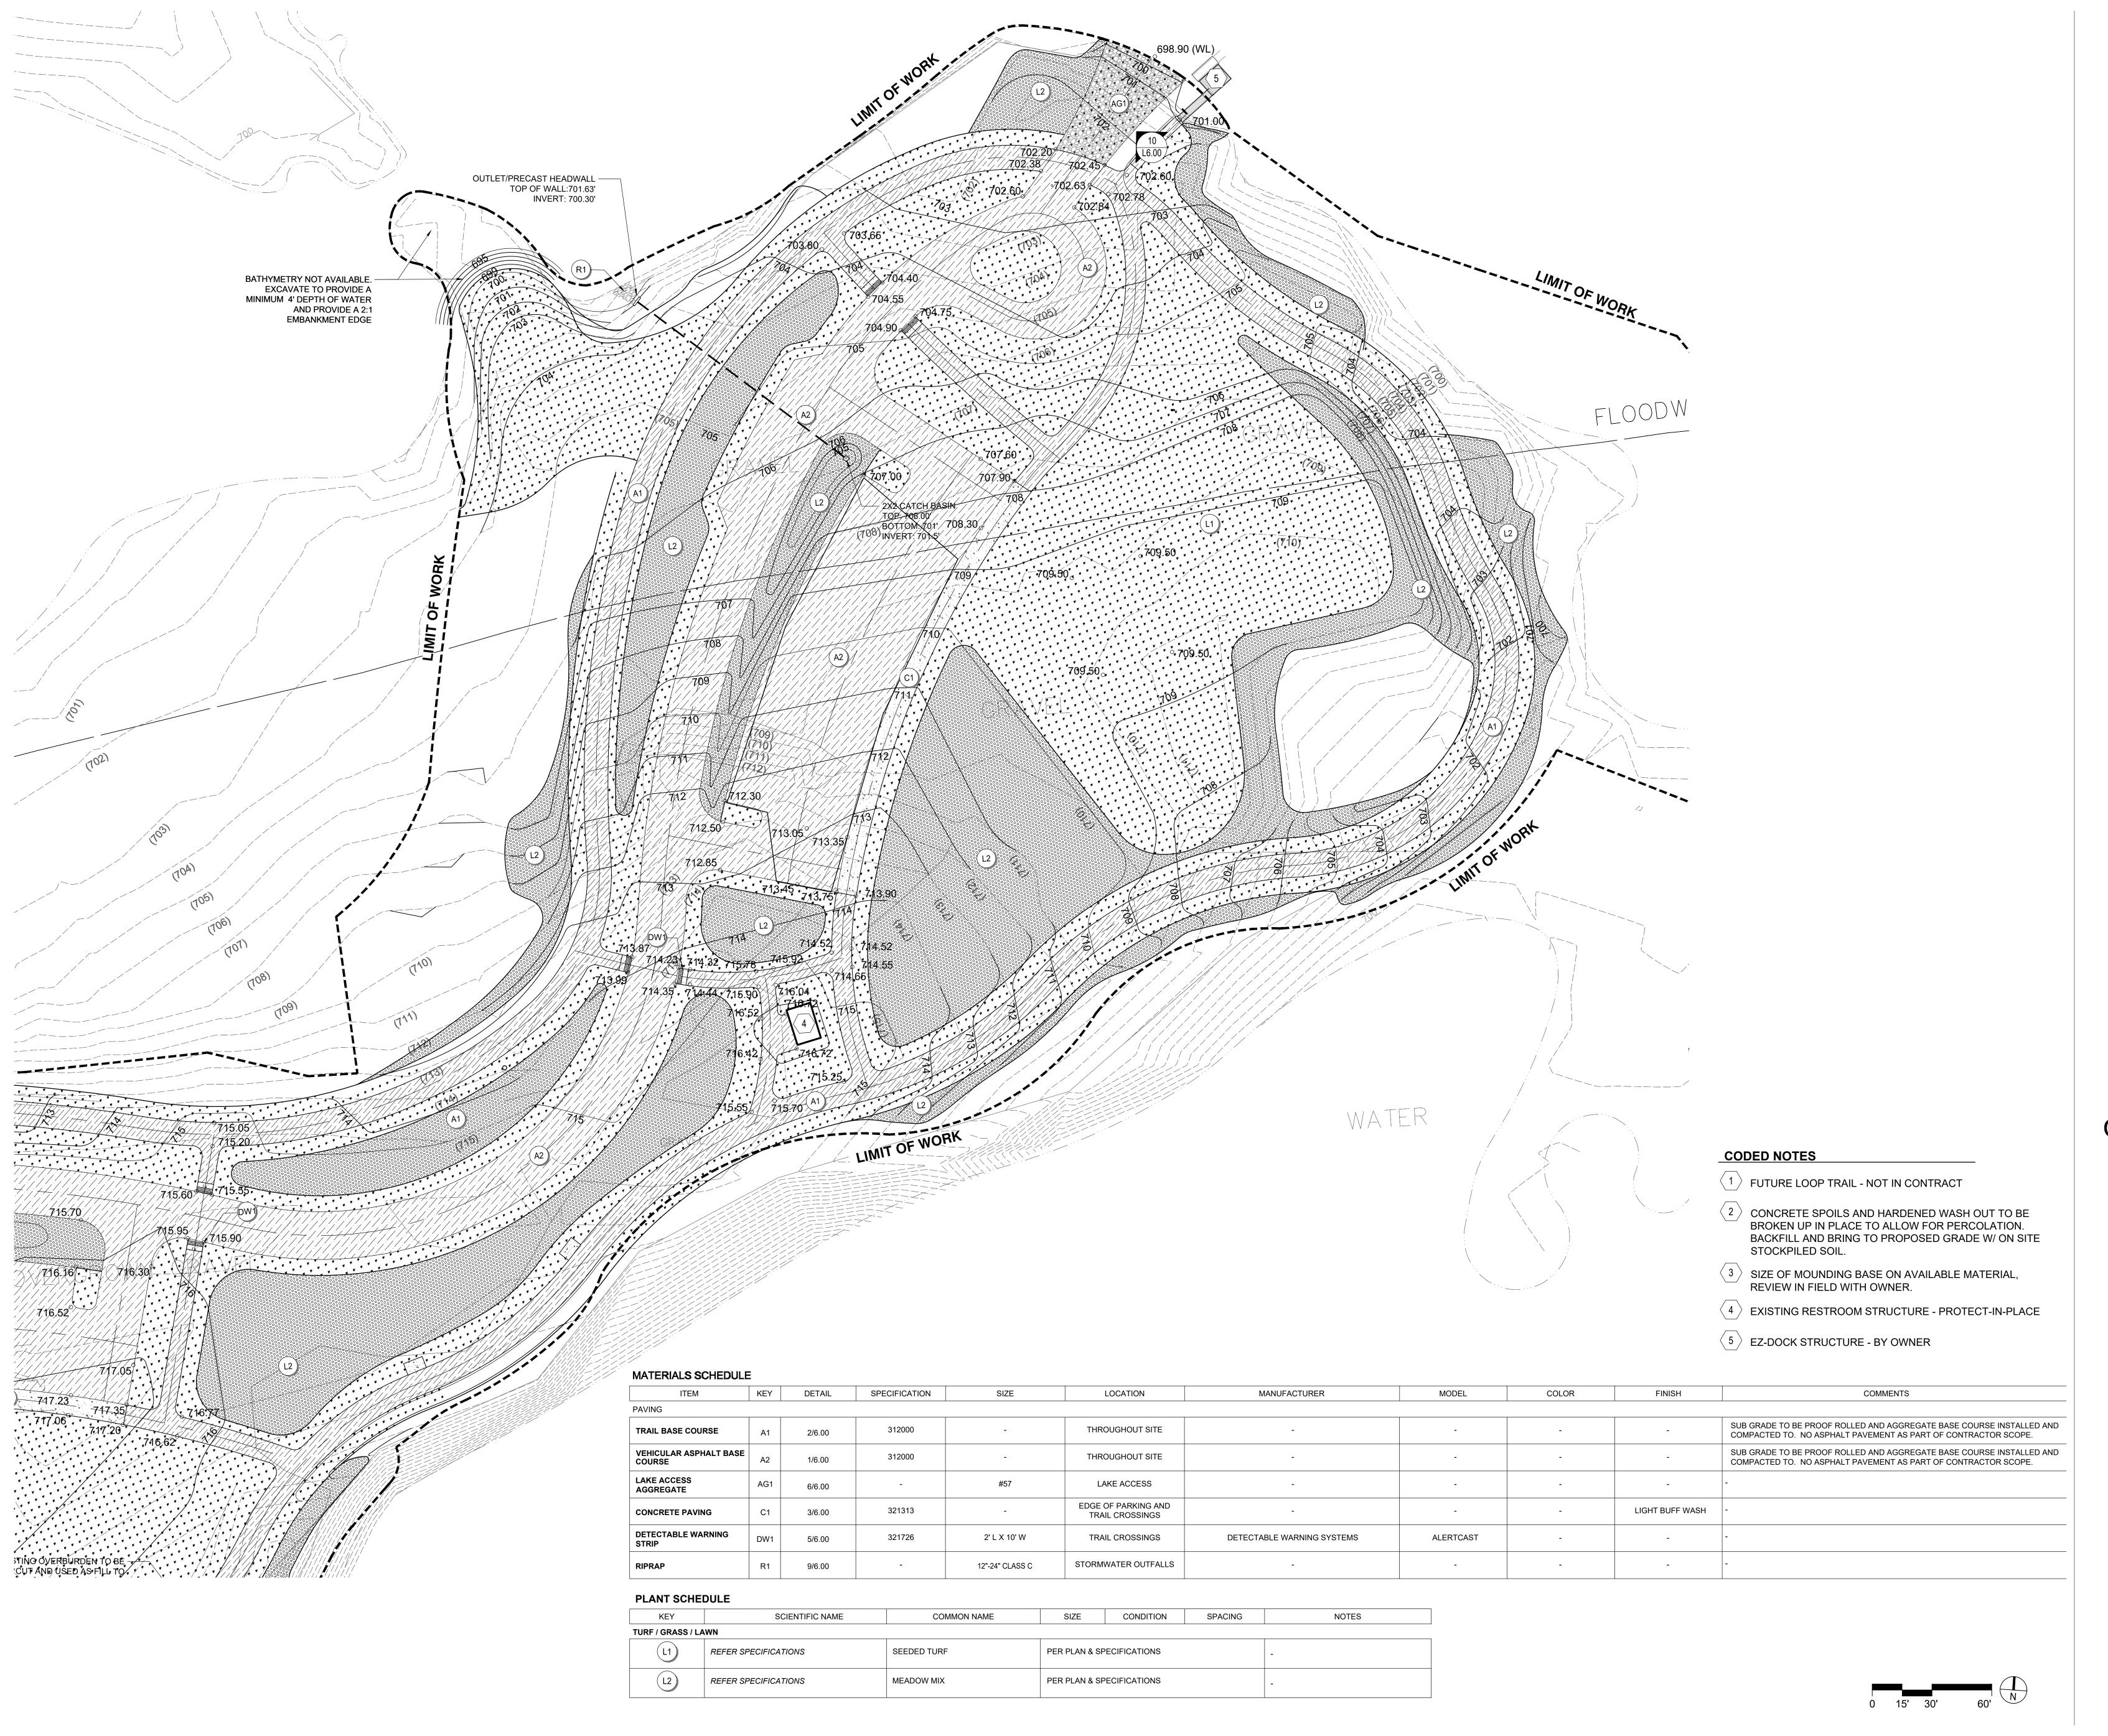
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MATERIALS, GRADING & PLANTING PLAN

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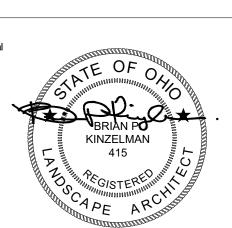
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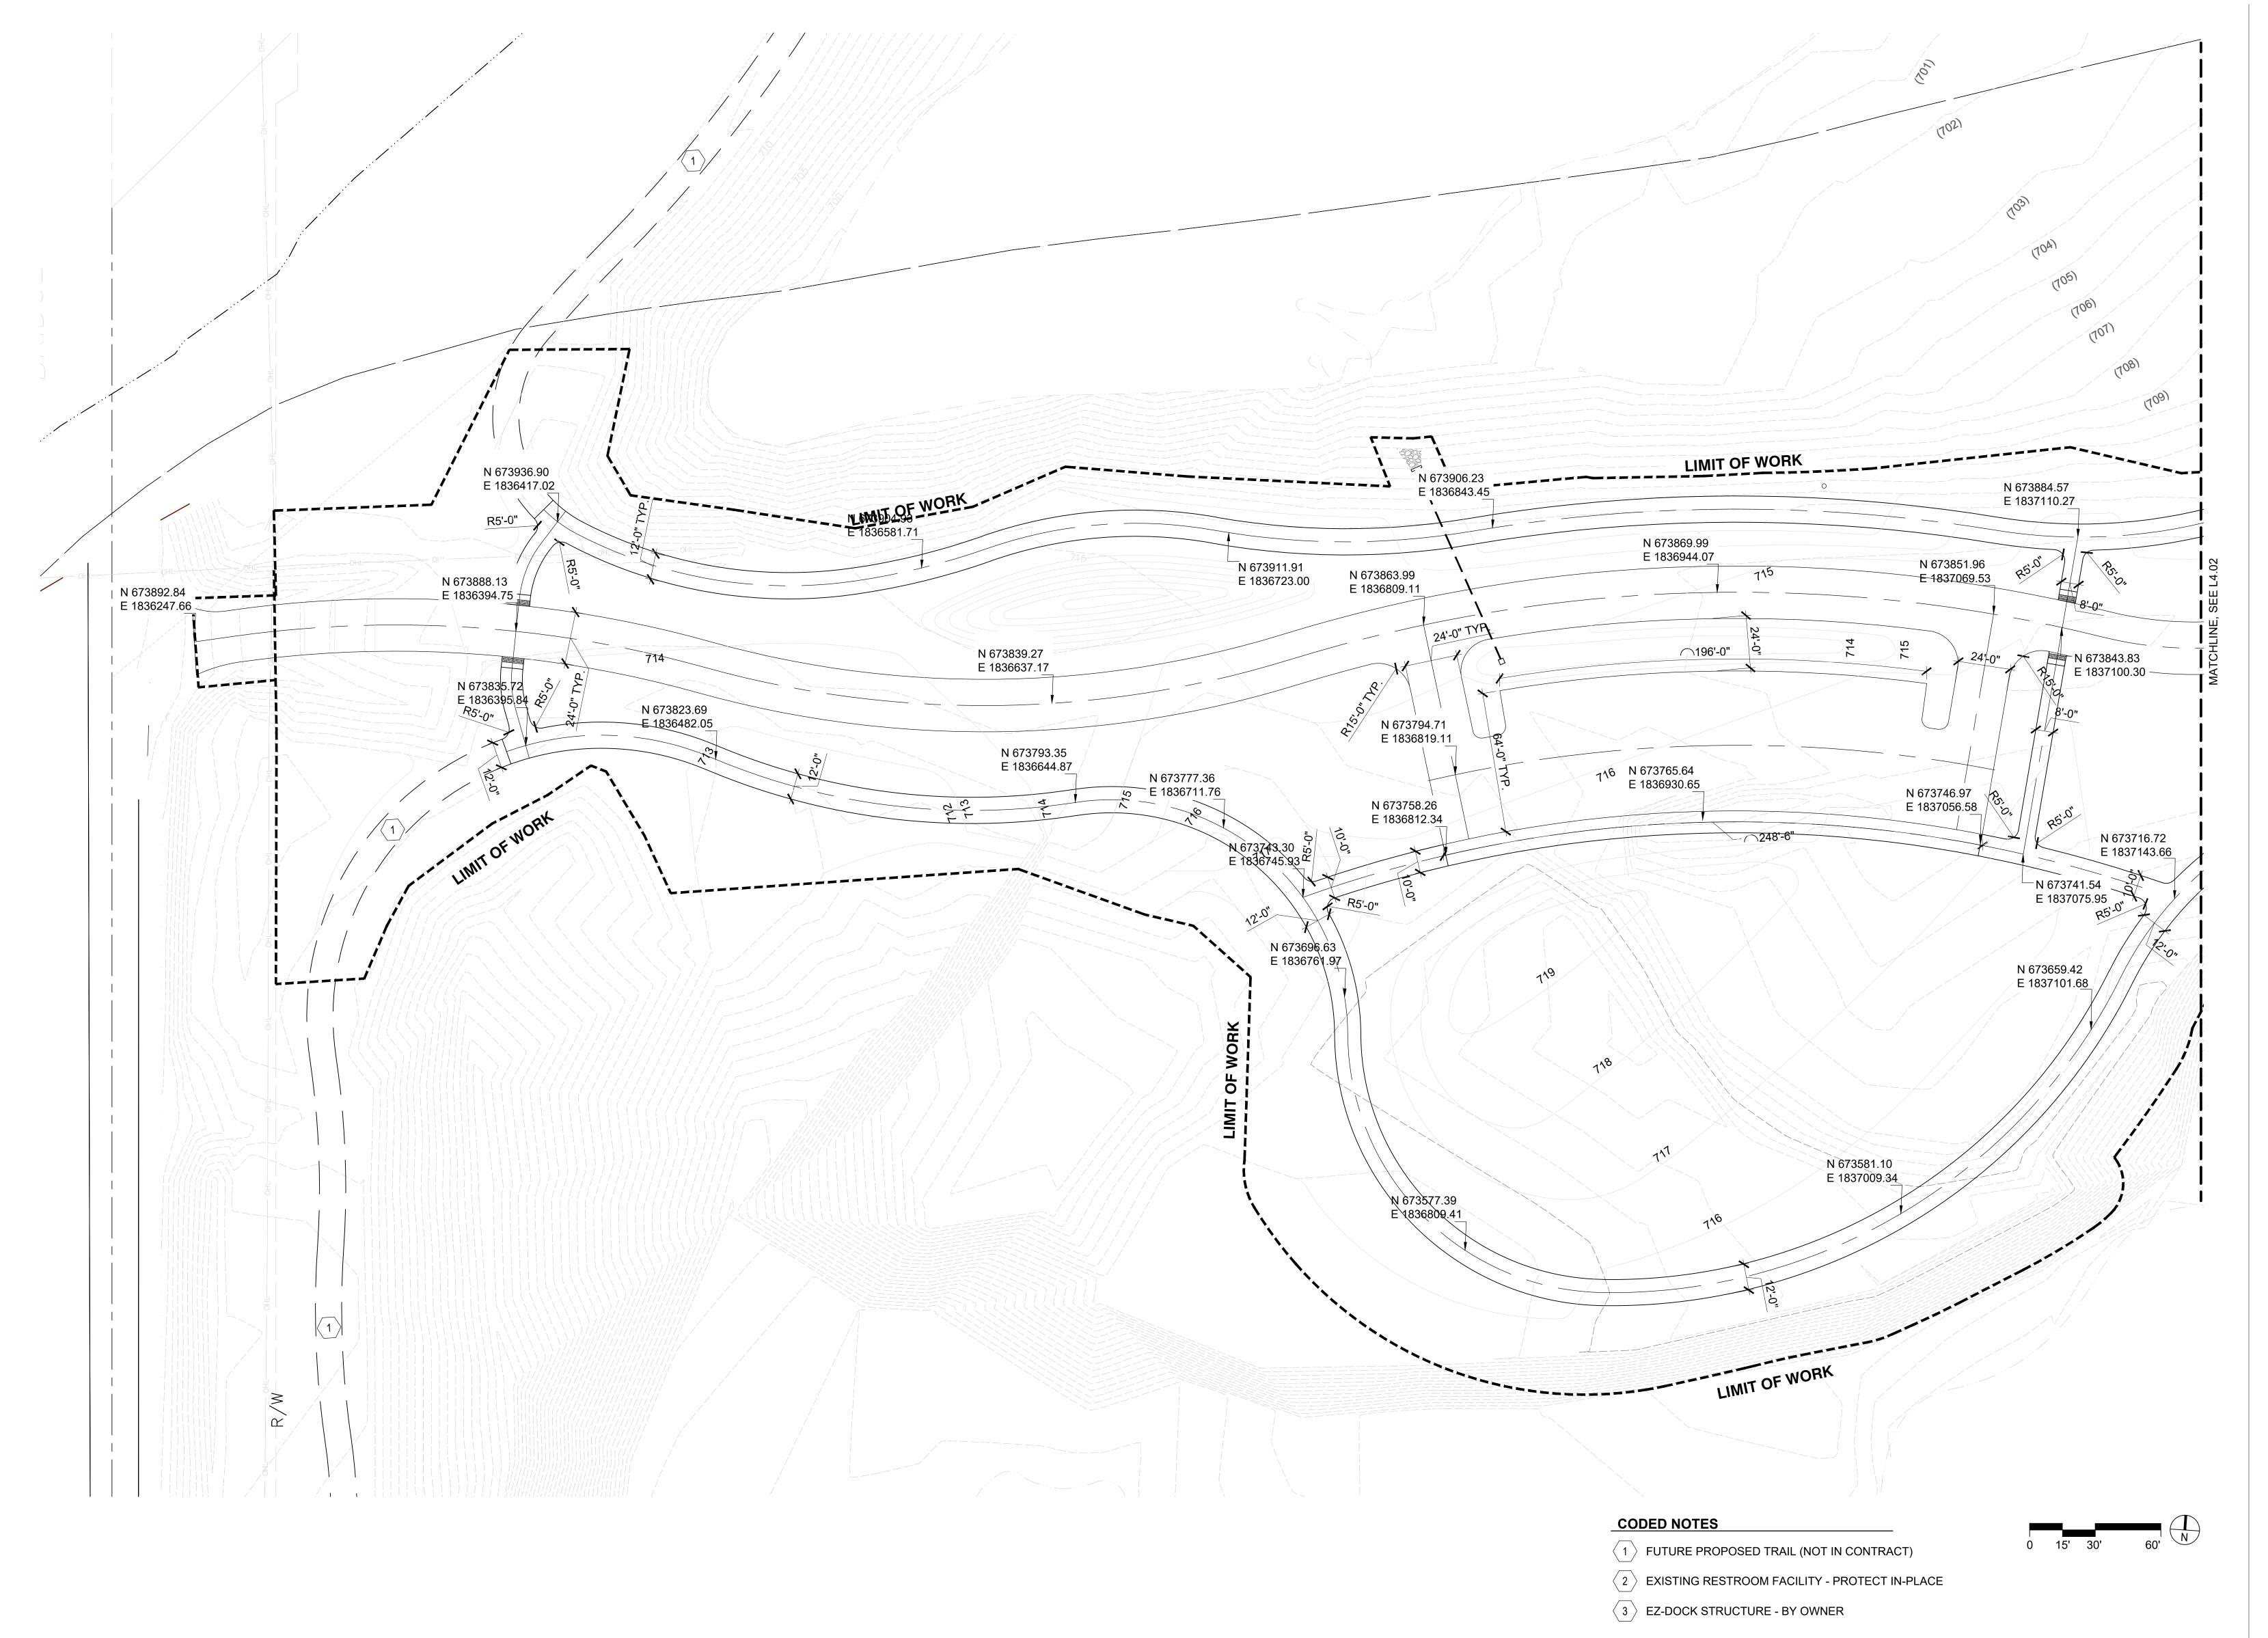
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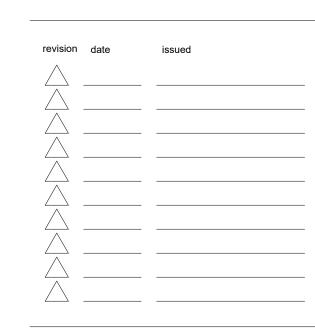
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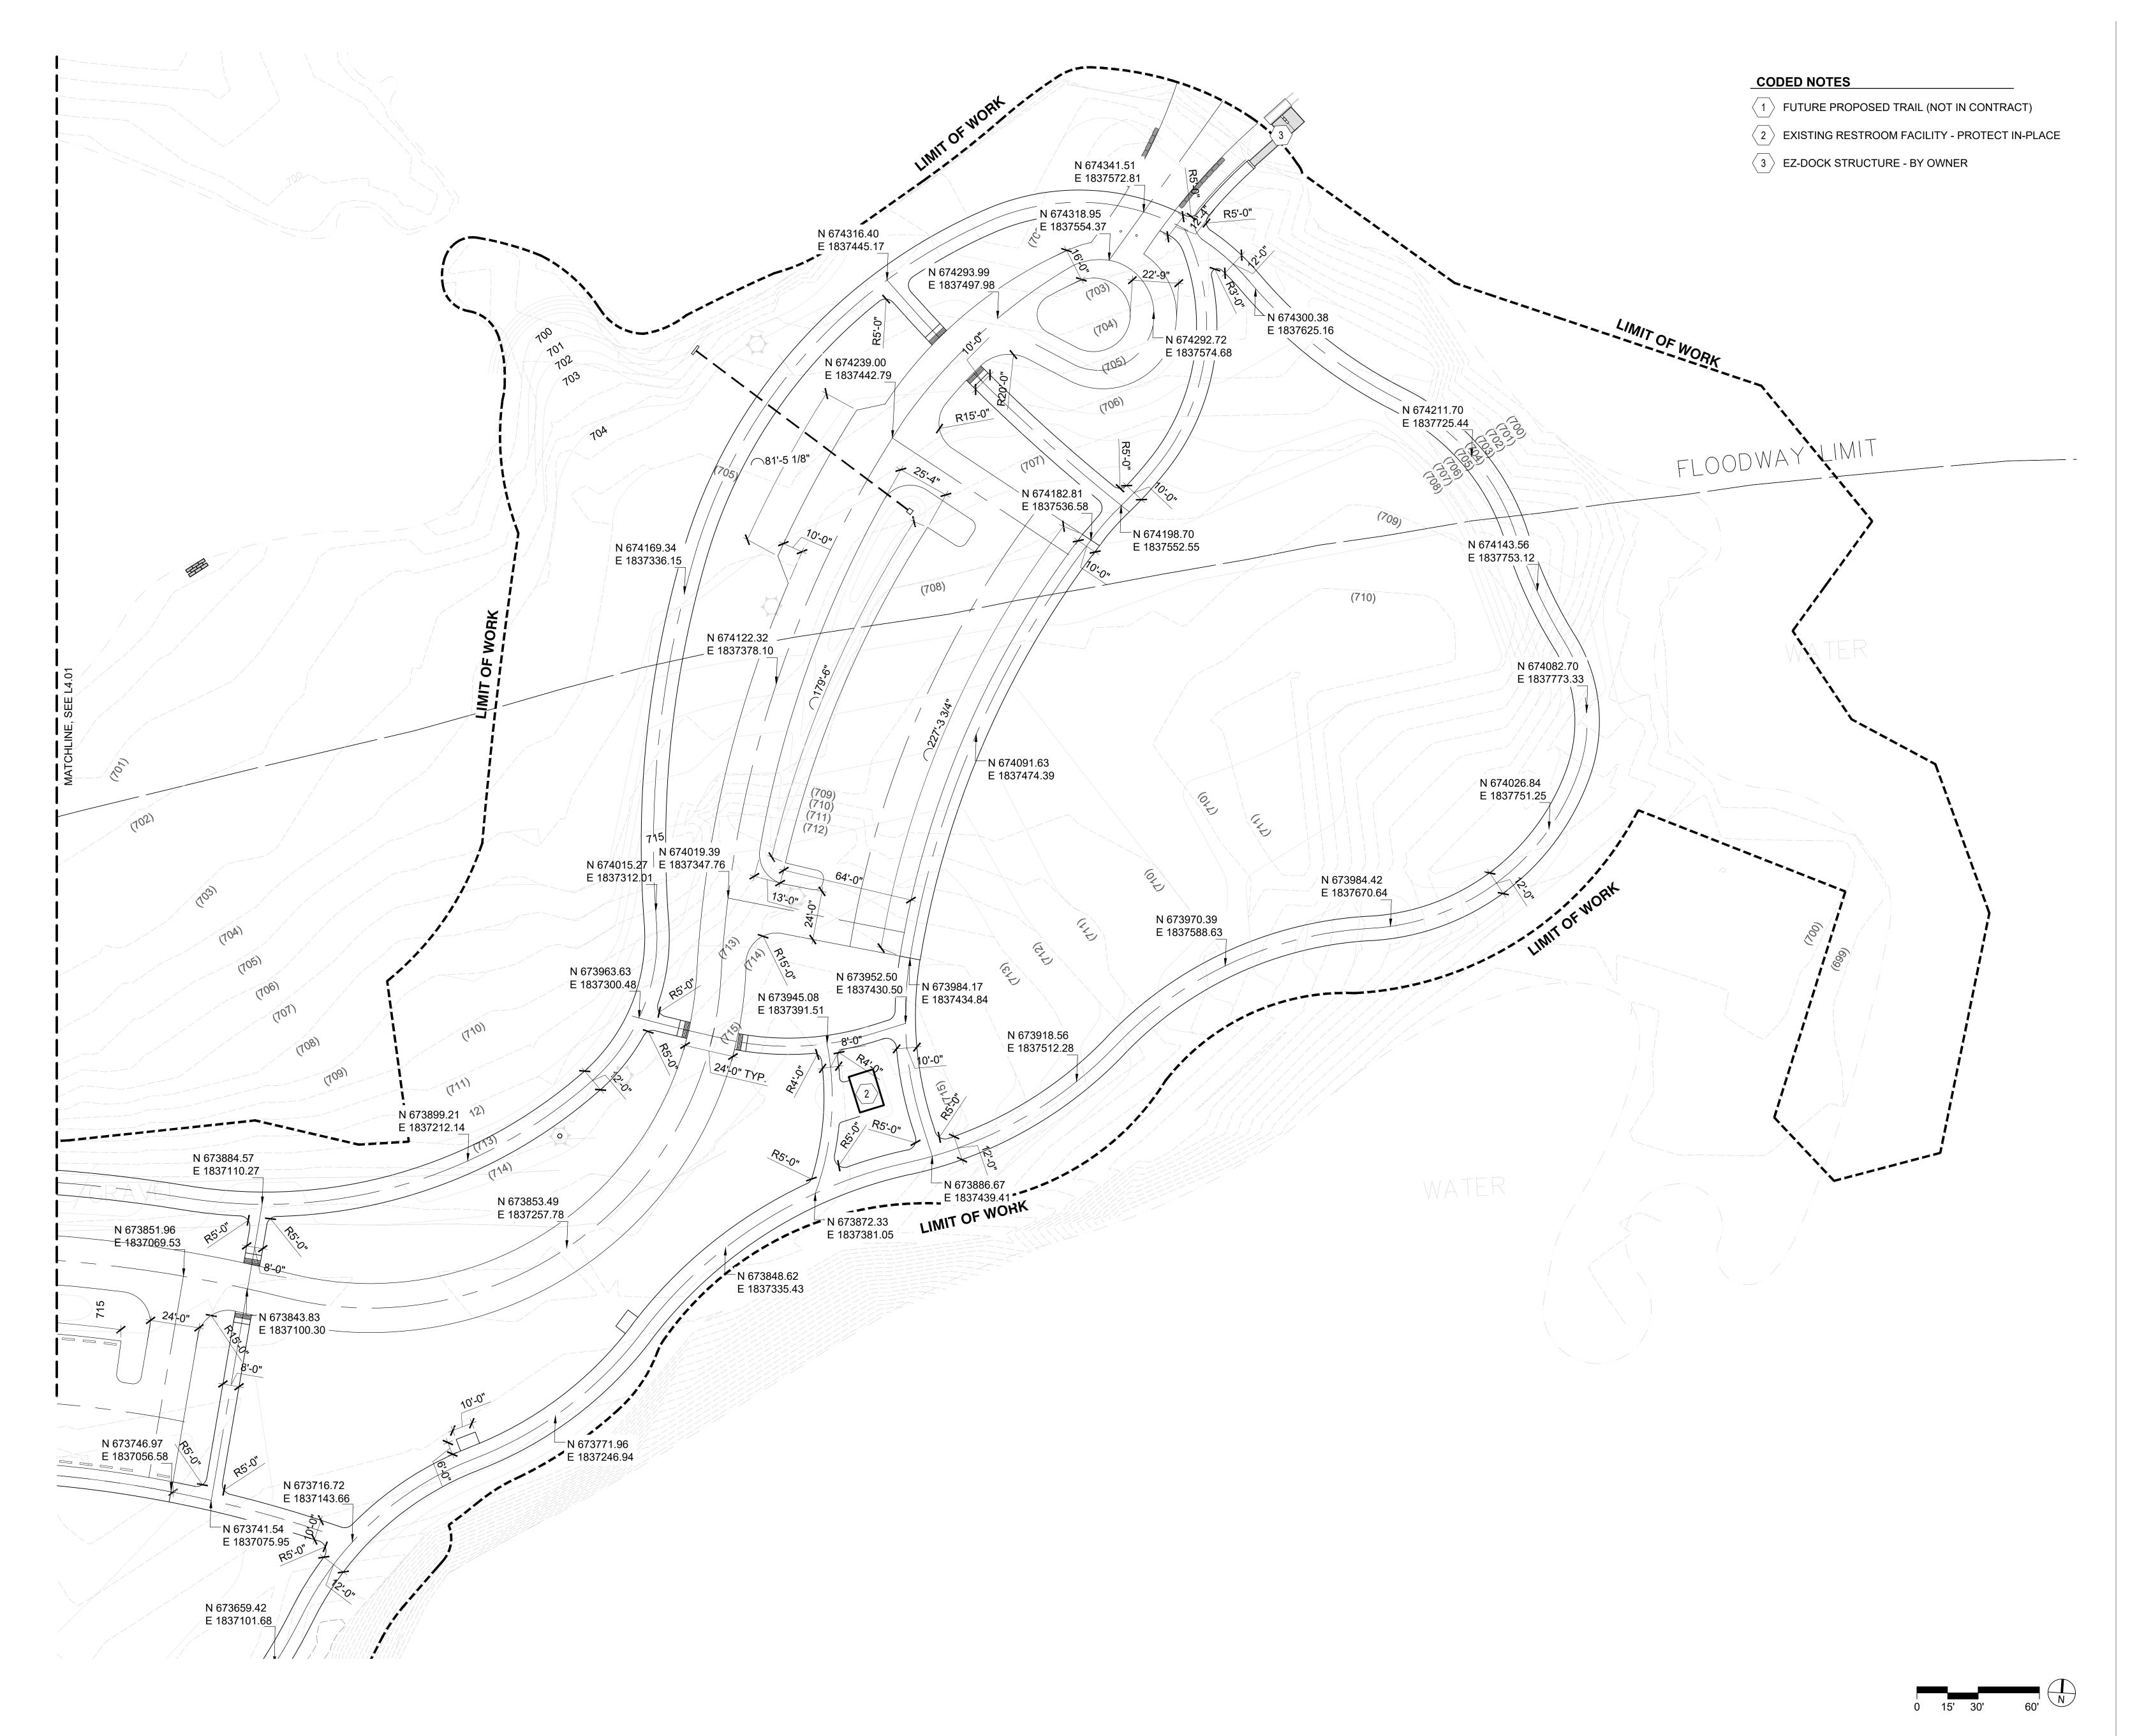


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LAYOUT PLAN

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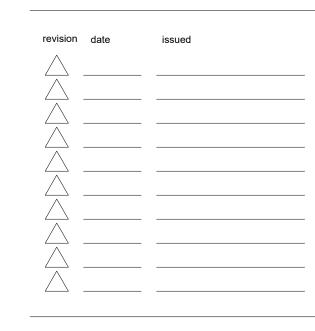
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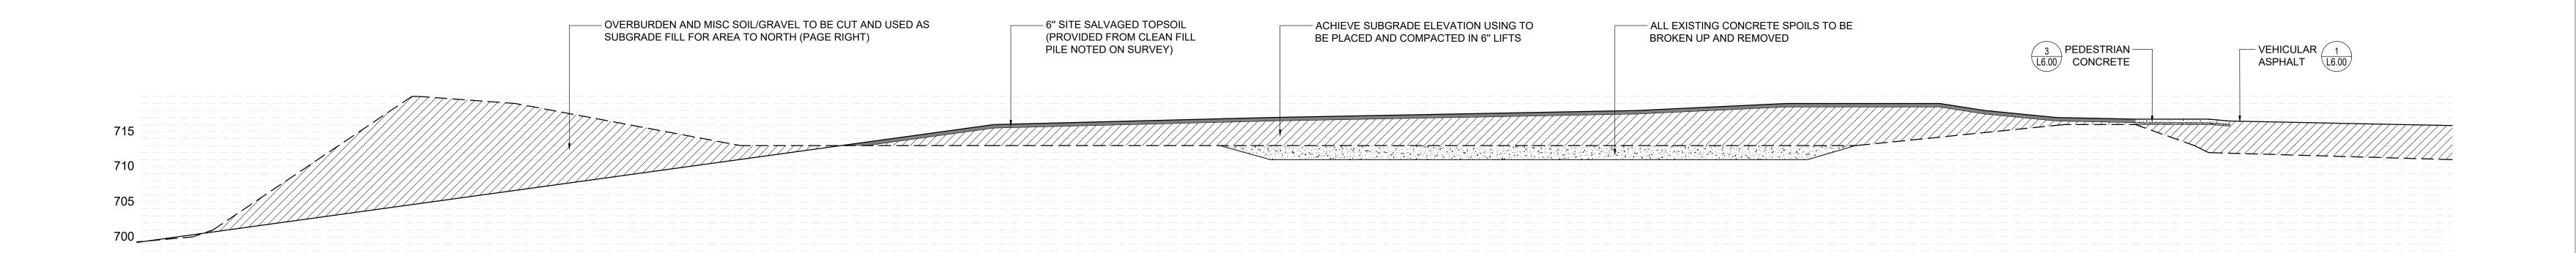
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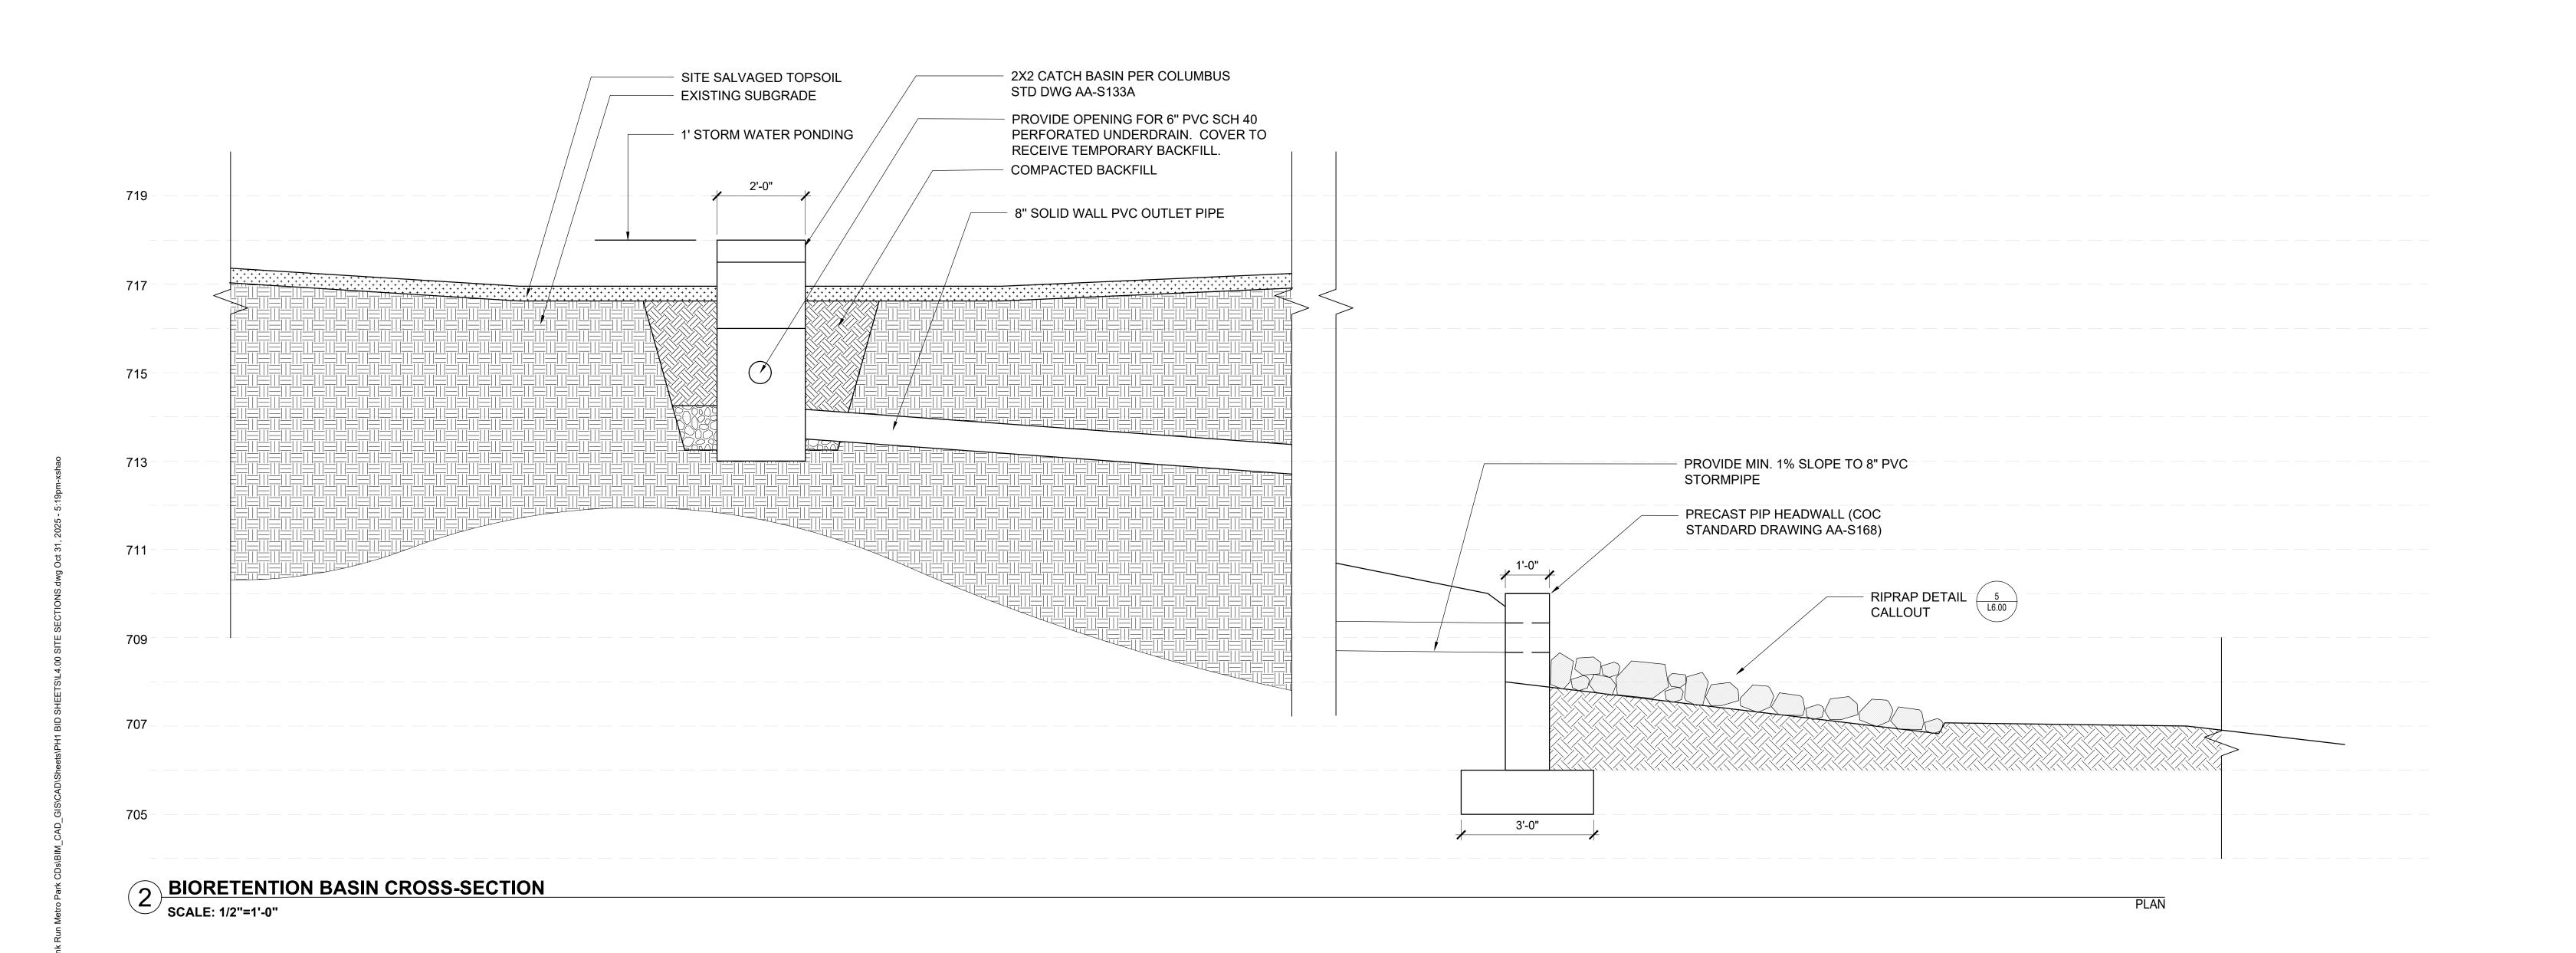
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SECTION THROUGH SOUTHERN LAWN

SCALE: 1" = 10'-0"

PLAN



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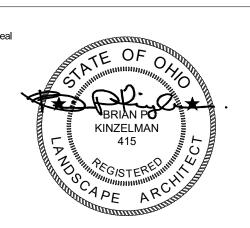
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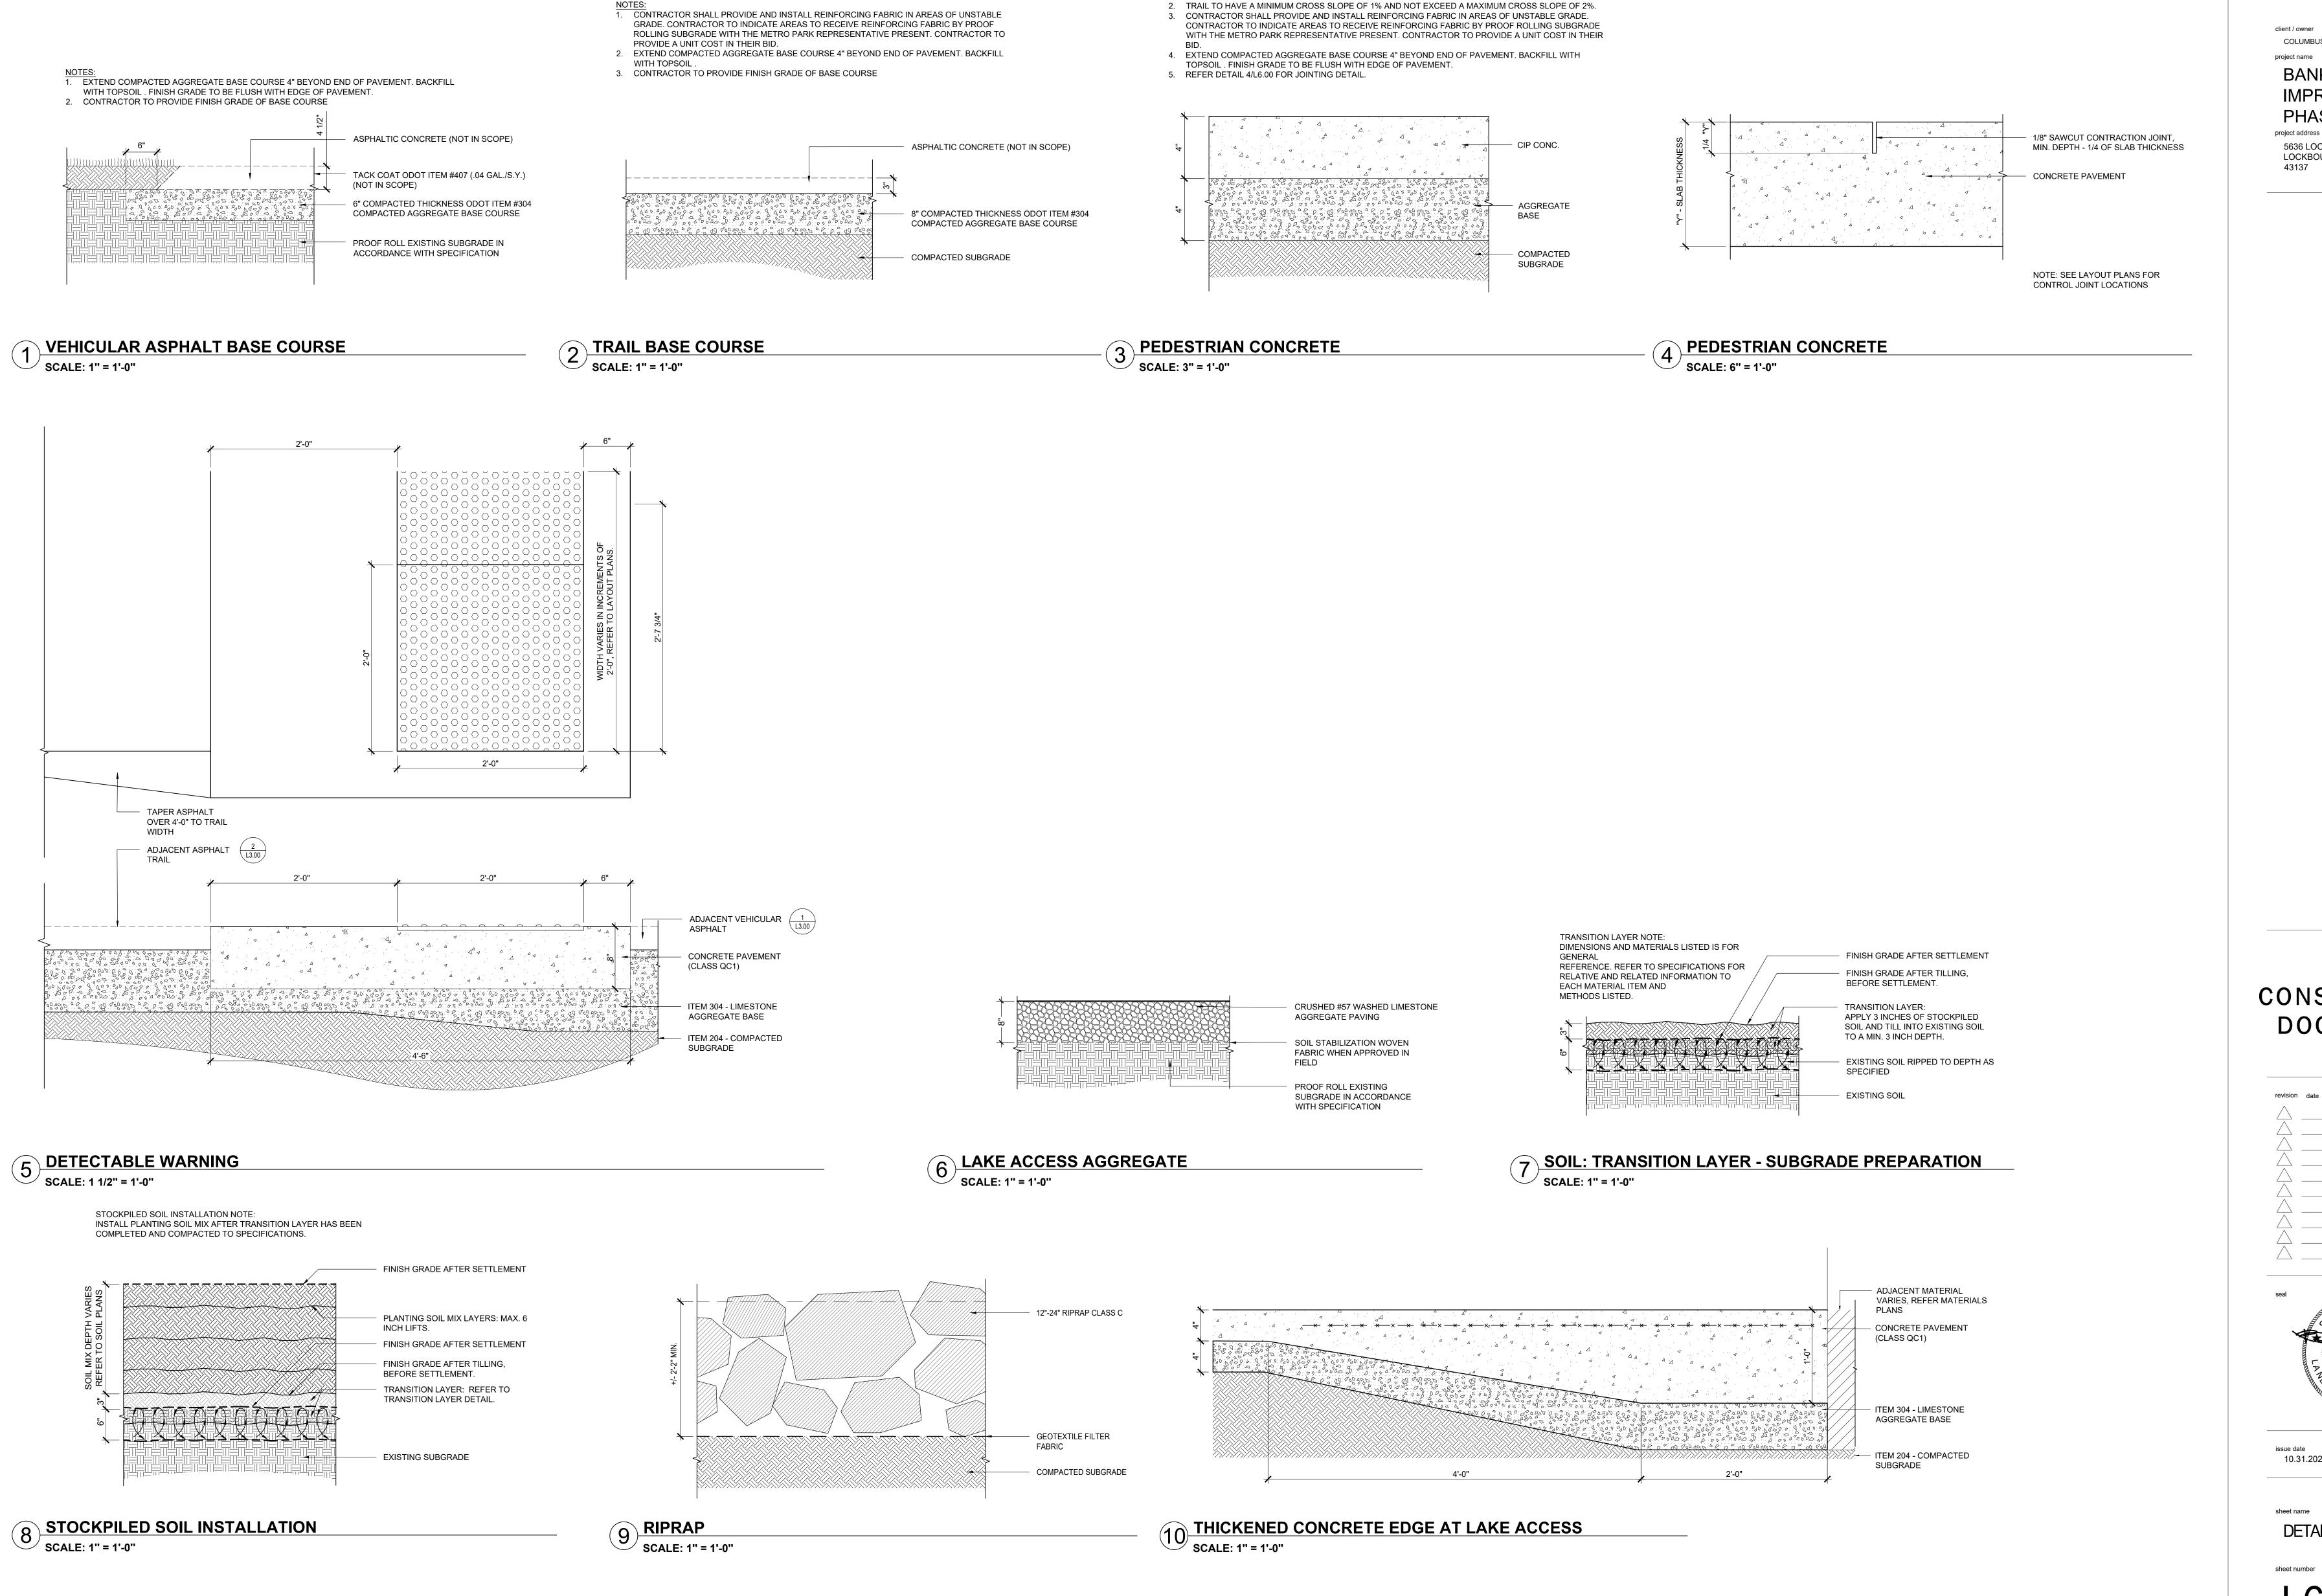
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SITE SECTIONS

sheet number

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1. THE CONTRACTOR SHALL INSTALL A MOCK-UP SECTION OF PATH 10' IN LENGTH TO BE APPROVED BY

OWNER'S REPRESENTATIVE PRIOR TO INSTALLATION. IF APPROVED, MOCK-UP MAY BE USED AS PART

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sheet name **DETAILS**

sheet number

L6.00